Lengths are in metres. Reduction Ratio 1:300

10 20 30 40 50 60 70 80 90 100 110 120 130 140 150

## 1-17 BARRETT AVENUE, THORNLEIGH

### ARCHITECTURAL

ARCHI	IECTURAL		
SHEET	SHEET NAME	REV	DATE
	·VT		
01 CONTE		DC	20/07/2025
DA-0000	COVER SHEET	P5	30/07/2025
DA-0002	SITE PLAN	P6	30/07/2025
DA-0003	SITE ANALYSIS	P5	30/07/2025
DA-0005	DEMOLITION PLAN	P5	30/07/2025
DA-0006	CUT AND FILL PLAN	P6	30/07/2025
DA-0007	SUBDIVISION PLAN	P6	30/07/2025
DA-0010	SITE ELEVATION & SECTION	P5	30/07/2025
02 GA PLA	ANS		
DA-2000	GA-GROUND FLOOR PLAN	P14	30/07/2025
DA-2001	GA-LEVEL 01 PLAN	P8	30/07/2025
DA-2001 DA-2002	GA-ROOF PLAN	P9	30/07/2025
DA-2002 DA-2100	ACCESS - SITE A - GROUND FLOOR PLAN	P2	30/07/2025
DA-2100	ACCESS - SITE B - GROUND FLOOR PLAN	P2	30/07/2025
DA-2101 DA-2103	ACCESS - SITE A - LEVEL 01 PLAN	P2	30/07/2025
DA-2103 DA-2104	ACCESS - SITE A - LEVEL 01 PLAN  ACCESS - SITE B - LEVEL 01 PLAN	P2	30/07/2025
DA-2104	ACCESS - SITE B - LEVEL OT FLAIN	Γ2	30/01/2023
03 ELEVA	TIONS		
DA-3000	STREETSCAPE ELEVATIONS	P6	30/07/2025
DA-3002	BUILDING ELEVATIONS A	P6	30/07/2025
DA-3003	BUILDING ELEVATIONS A	P6	30/07/2025
DA-3004	BUILDING ELEVATIONS B	P6	30/07/2025
DA-3005	BUILDING ELEVATIONS B	P6	30/07/2025
DA-3006	BUILDING ELEVATIONS C	P6	30/07/2025
DA-3007	BUILDING ELEVATIONS C	P6	30/07/2025
D/ (-000/	BOILDING ELL VICTIONS O	10	00/01/2020
04 SECTIO	ONS		
DA-4000	BUILDING SECTIONS	P6	30/07/2025
DA-4001	BUILDING SECTIONS	P6	30/07/2025
DA-4002	BUILDING SECTIONS	P6	30/07/2025
05 COMPL	IANCE PLANS		
DA-5000	GFA CALCULATIONS	P5	30/07/2025
DA-5001	LANDSCAPE & DEEP SOIL CALCULATION	P5	30/07/2025
DA-5002	LANDSCAPE PATH/FENCE DETAILING	P5	30/07/2025
DA-5003	SHADOW DIAGRAM ANALYSIS	P6	30/07/2025
DA-5004	SHADOW DIAGRAM ANALYSIS - 30A OAKLEIGH	P2	30/07/2025
	AVENUE		
DA-5005	SHADOW DIAGRAM ANALYSIS - 30A OAKLEIGH	P2	30/07/2025
DA 5006	AVENUE	DE	20/07/2025
DA-5006	SOLAR ACCESS DIAGRAMS	P5	30/07/2025
DA-5007	STORAGE COMPLIANCE	P5	30/07/2025
DA-5008	ACCESSIBILITY BUS ROUTES	P2	30/07/2025
DA-5100	SOLAR VIEW JUNE 21ST 9.00AM	P5	30/07/2025
DA-5101	SOLAR VIEW JUNE 21ST 10.00AM	P5	30/07/2025
DA-5102	SOLAR VIEW JUNE 21ST 10.30AM	P5	30/07/2025
DA-5103	SOLAR VIEW JUNE 21ST 11AM	P5	30/07/2025
DA-5104	SOLAR VIEW JUNE 21ST 12PM	P5	30/07/2025
DA-5105	SOLAR VIEW JUNE 21ST 1PM	P5	30/07/2025
DA-5106	SOLAR VIEW JUNE 21ST 2PM	P5	30/07/2025
DA-5107	SOLAR VIEW JUNE 21ST 2.30PM	P5	30/07/2025
DA-5108	SOLAR VIEW JUNE 21ST 3PM	P5	30/07/2025
DA-5200	HEIGHT COMPLIANCE DIAGRAM	P5	30/07/2025
DA-5201	POS & BALCONY AREA COMPLIANCE LEVEL 1	P5	30/07/2025
DA-5202	POS & BALCONY AREA COMPLIANCE- LEVEL 1	P5	30/07/2025



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LEGEND:

SCALE: @ A1

PROJECT: #2023103 1-17 BARRETT AVE THORNLEIGH


DRAWING TITLE: **COVER SHEET** 

SHEET NUMBER:

**DA-0000** 

DATE: 30/07/2025

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LEGEND:

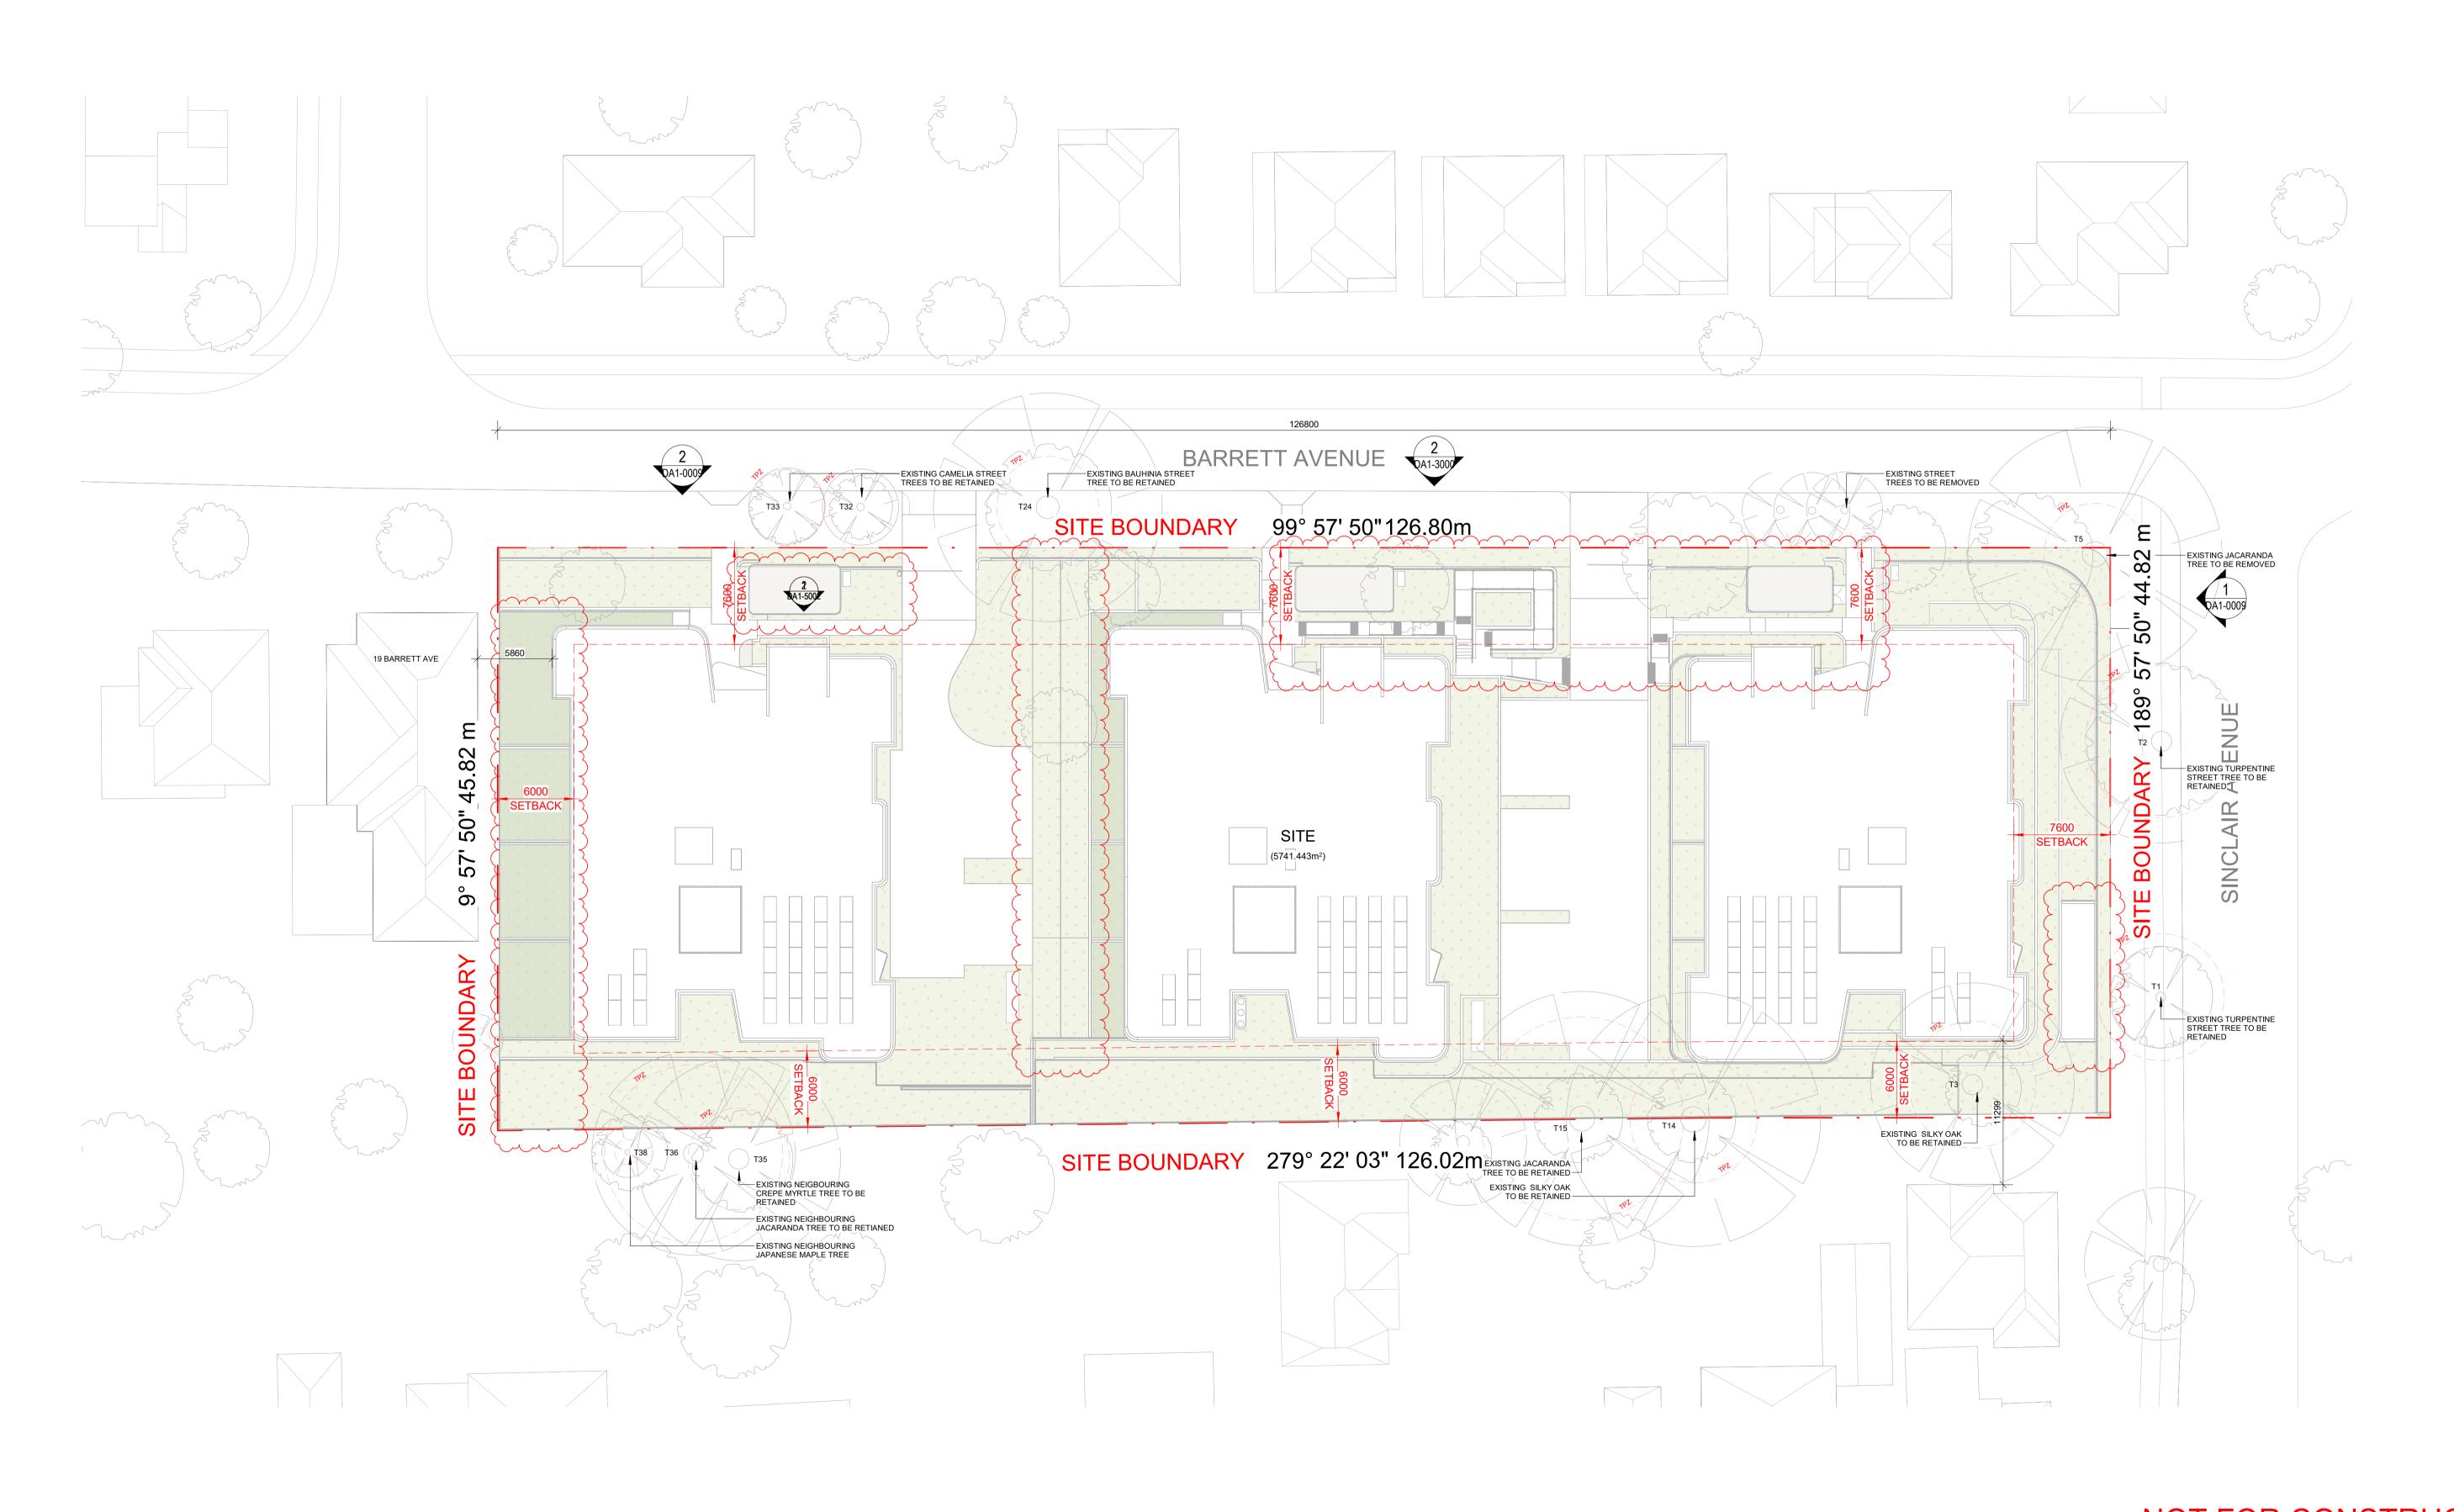
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PROJECT: #2023103 1-17 BARRETT AVE THORNLEIGH

DRAWING TITLE: SITE PLAN

SHEET NUMBER: **DA-0002** DATE: 30/07/2025

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precedence over drawings made to smaller scales or for general purposes. All work is to conform to relevant Australian Standards and Codes together with all Authorities' requirements and Regulations.

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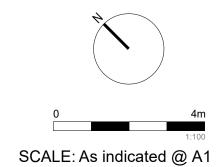
 P2
 03/09/2024
 FOR INFORMATION

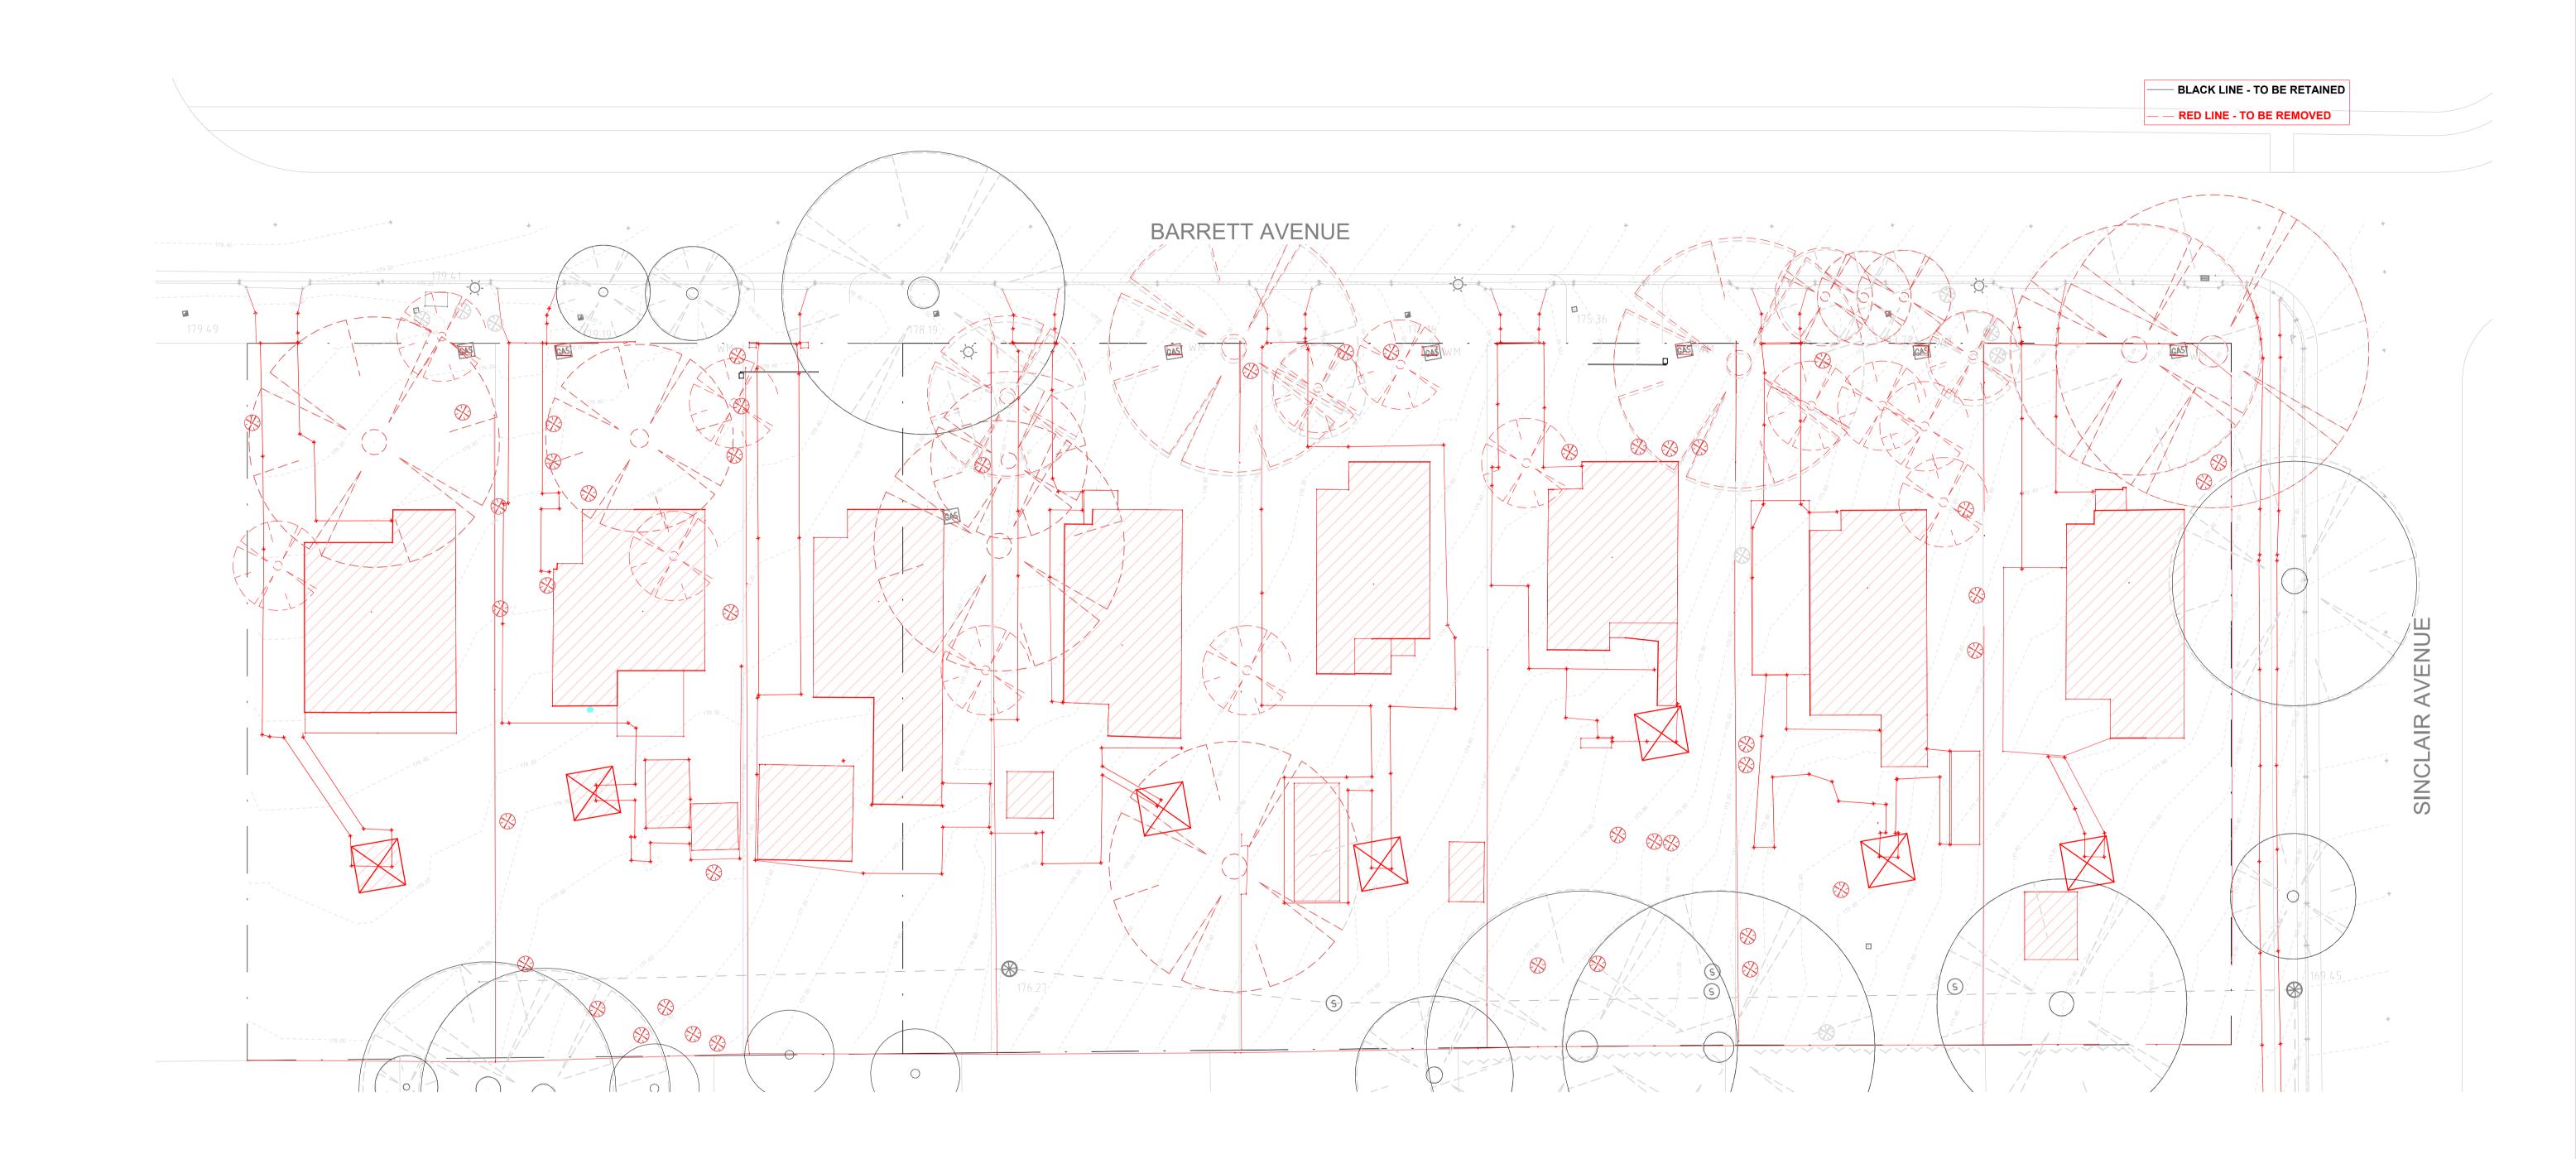 P3
 04/11/2024
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 P4
 06/12/2024
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 30/07/2025
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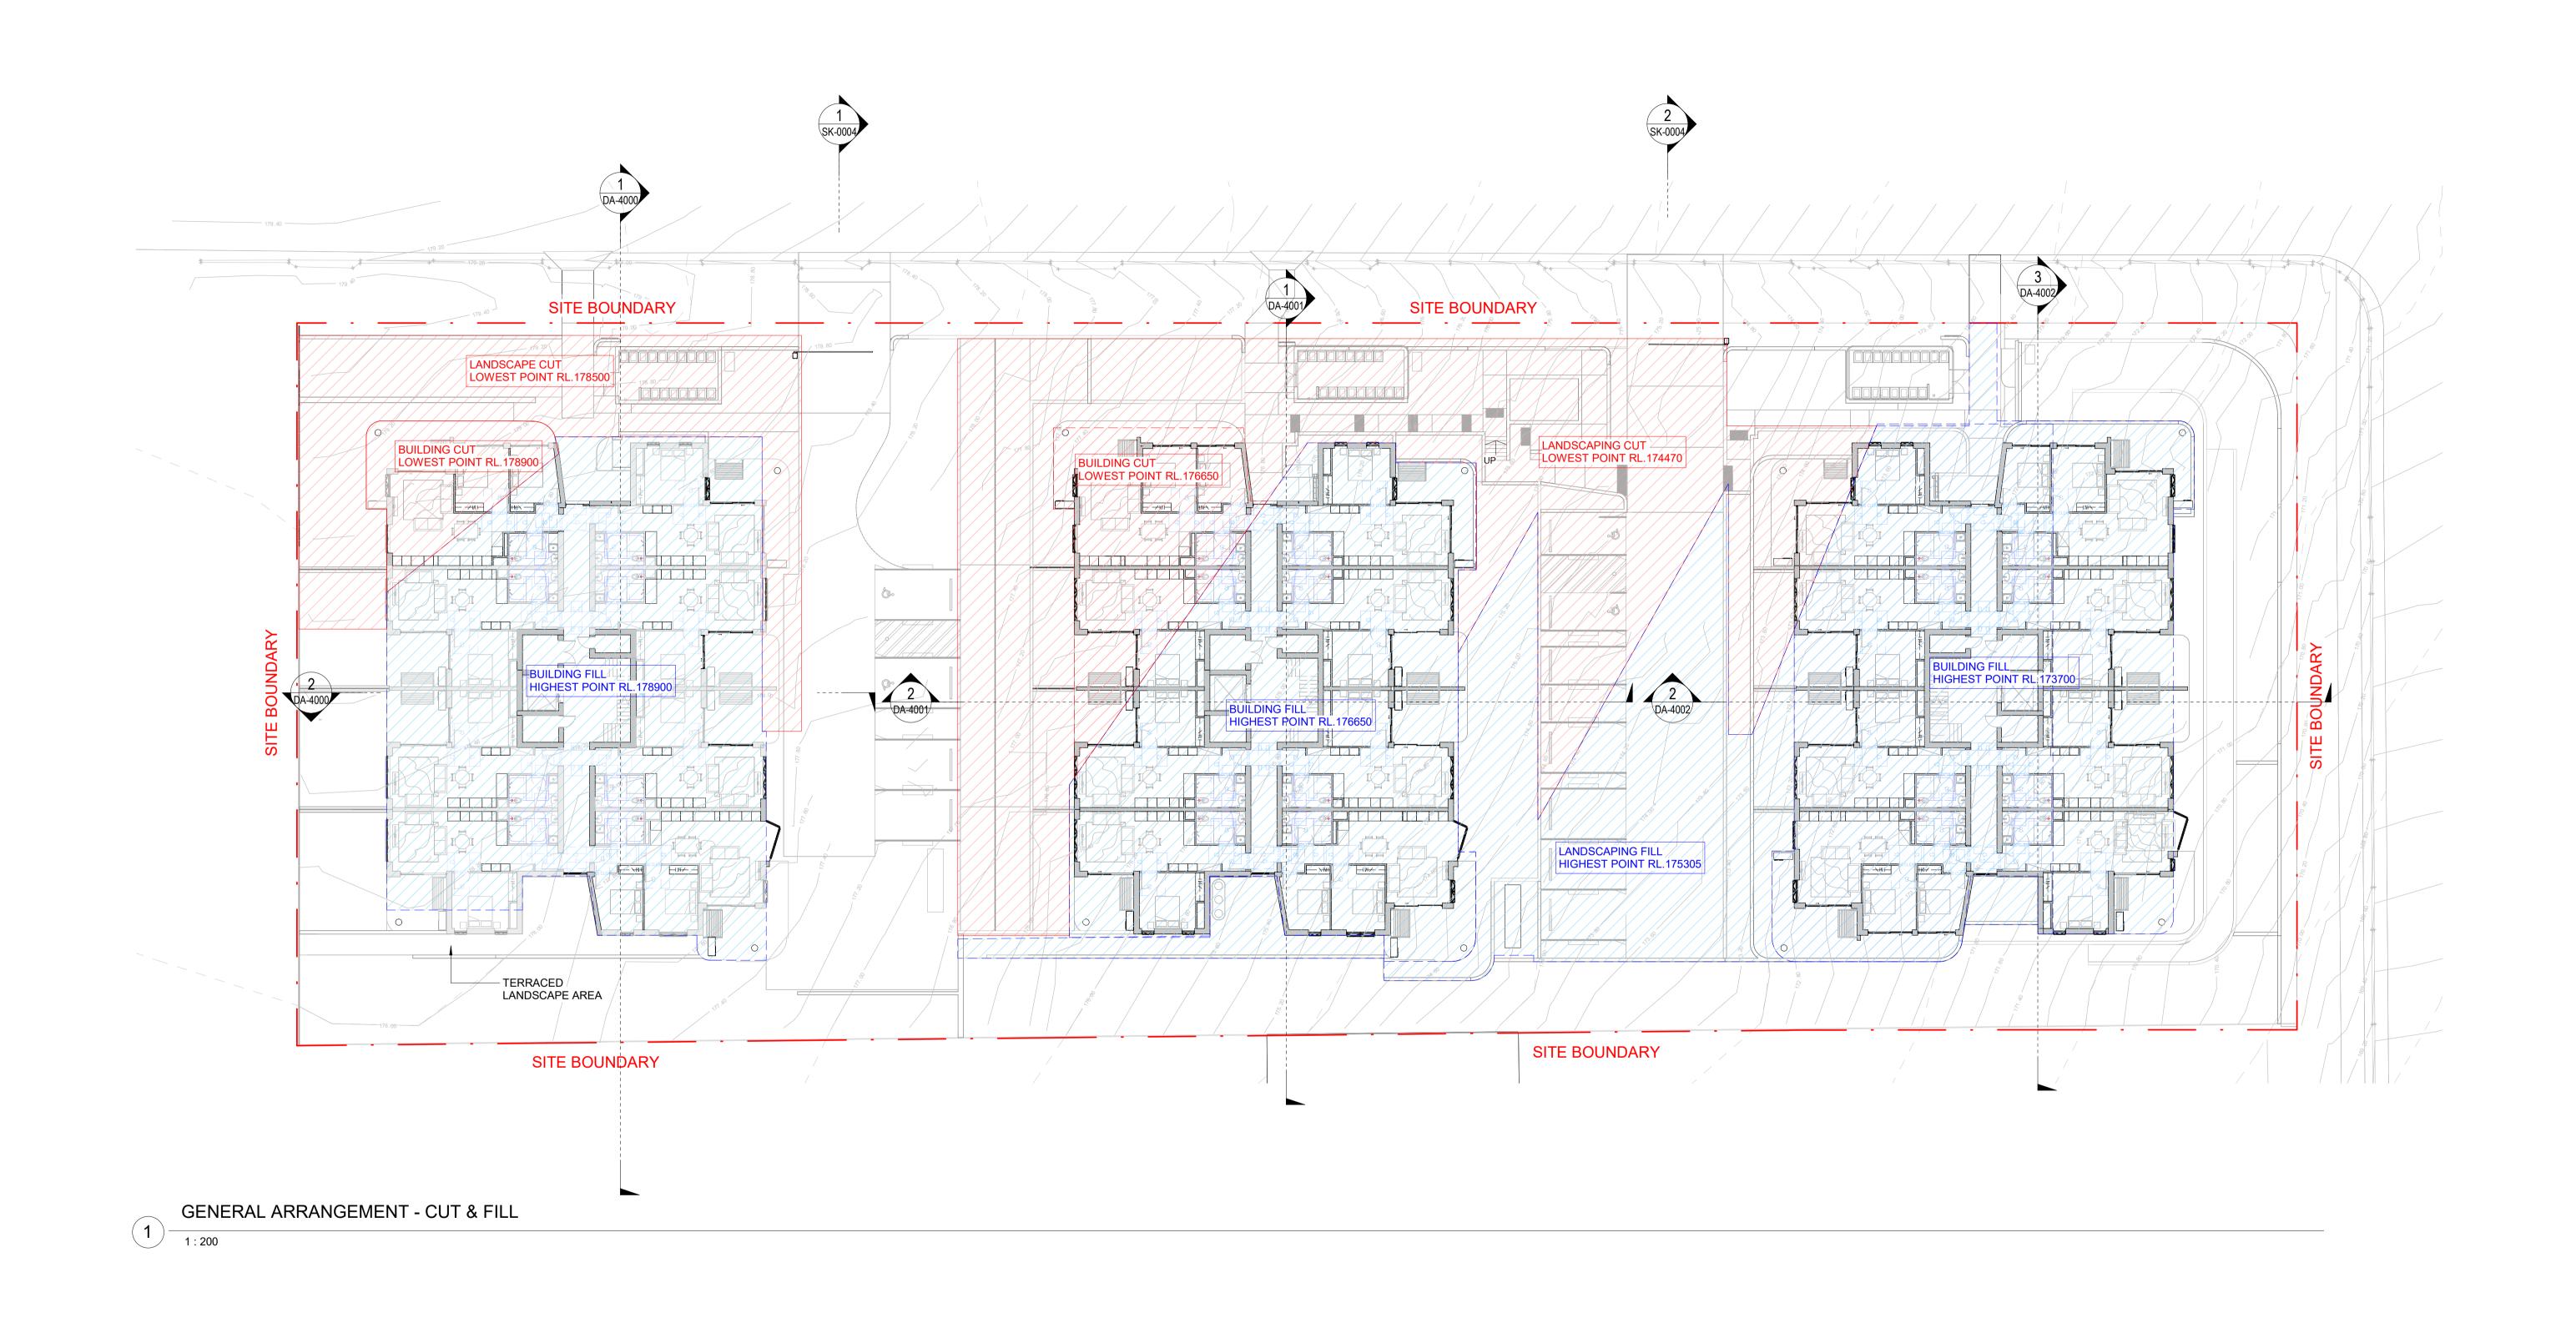
#2023103
1-17 BARRETT AVE
THORNLEIGH

DEMOLITION PLAN

DATE: 30/07/2025

SHEET NUMBER: REV





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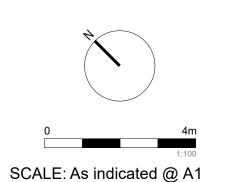
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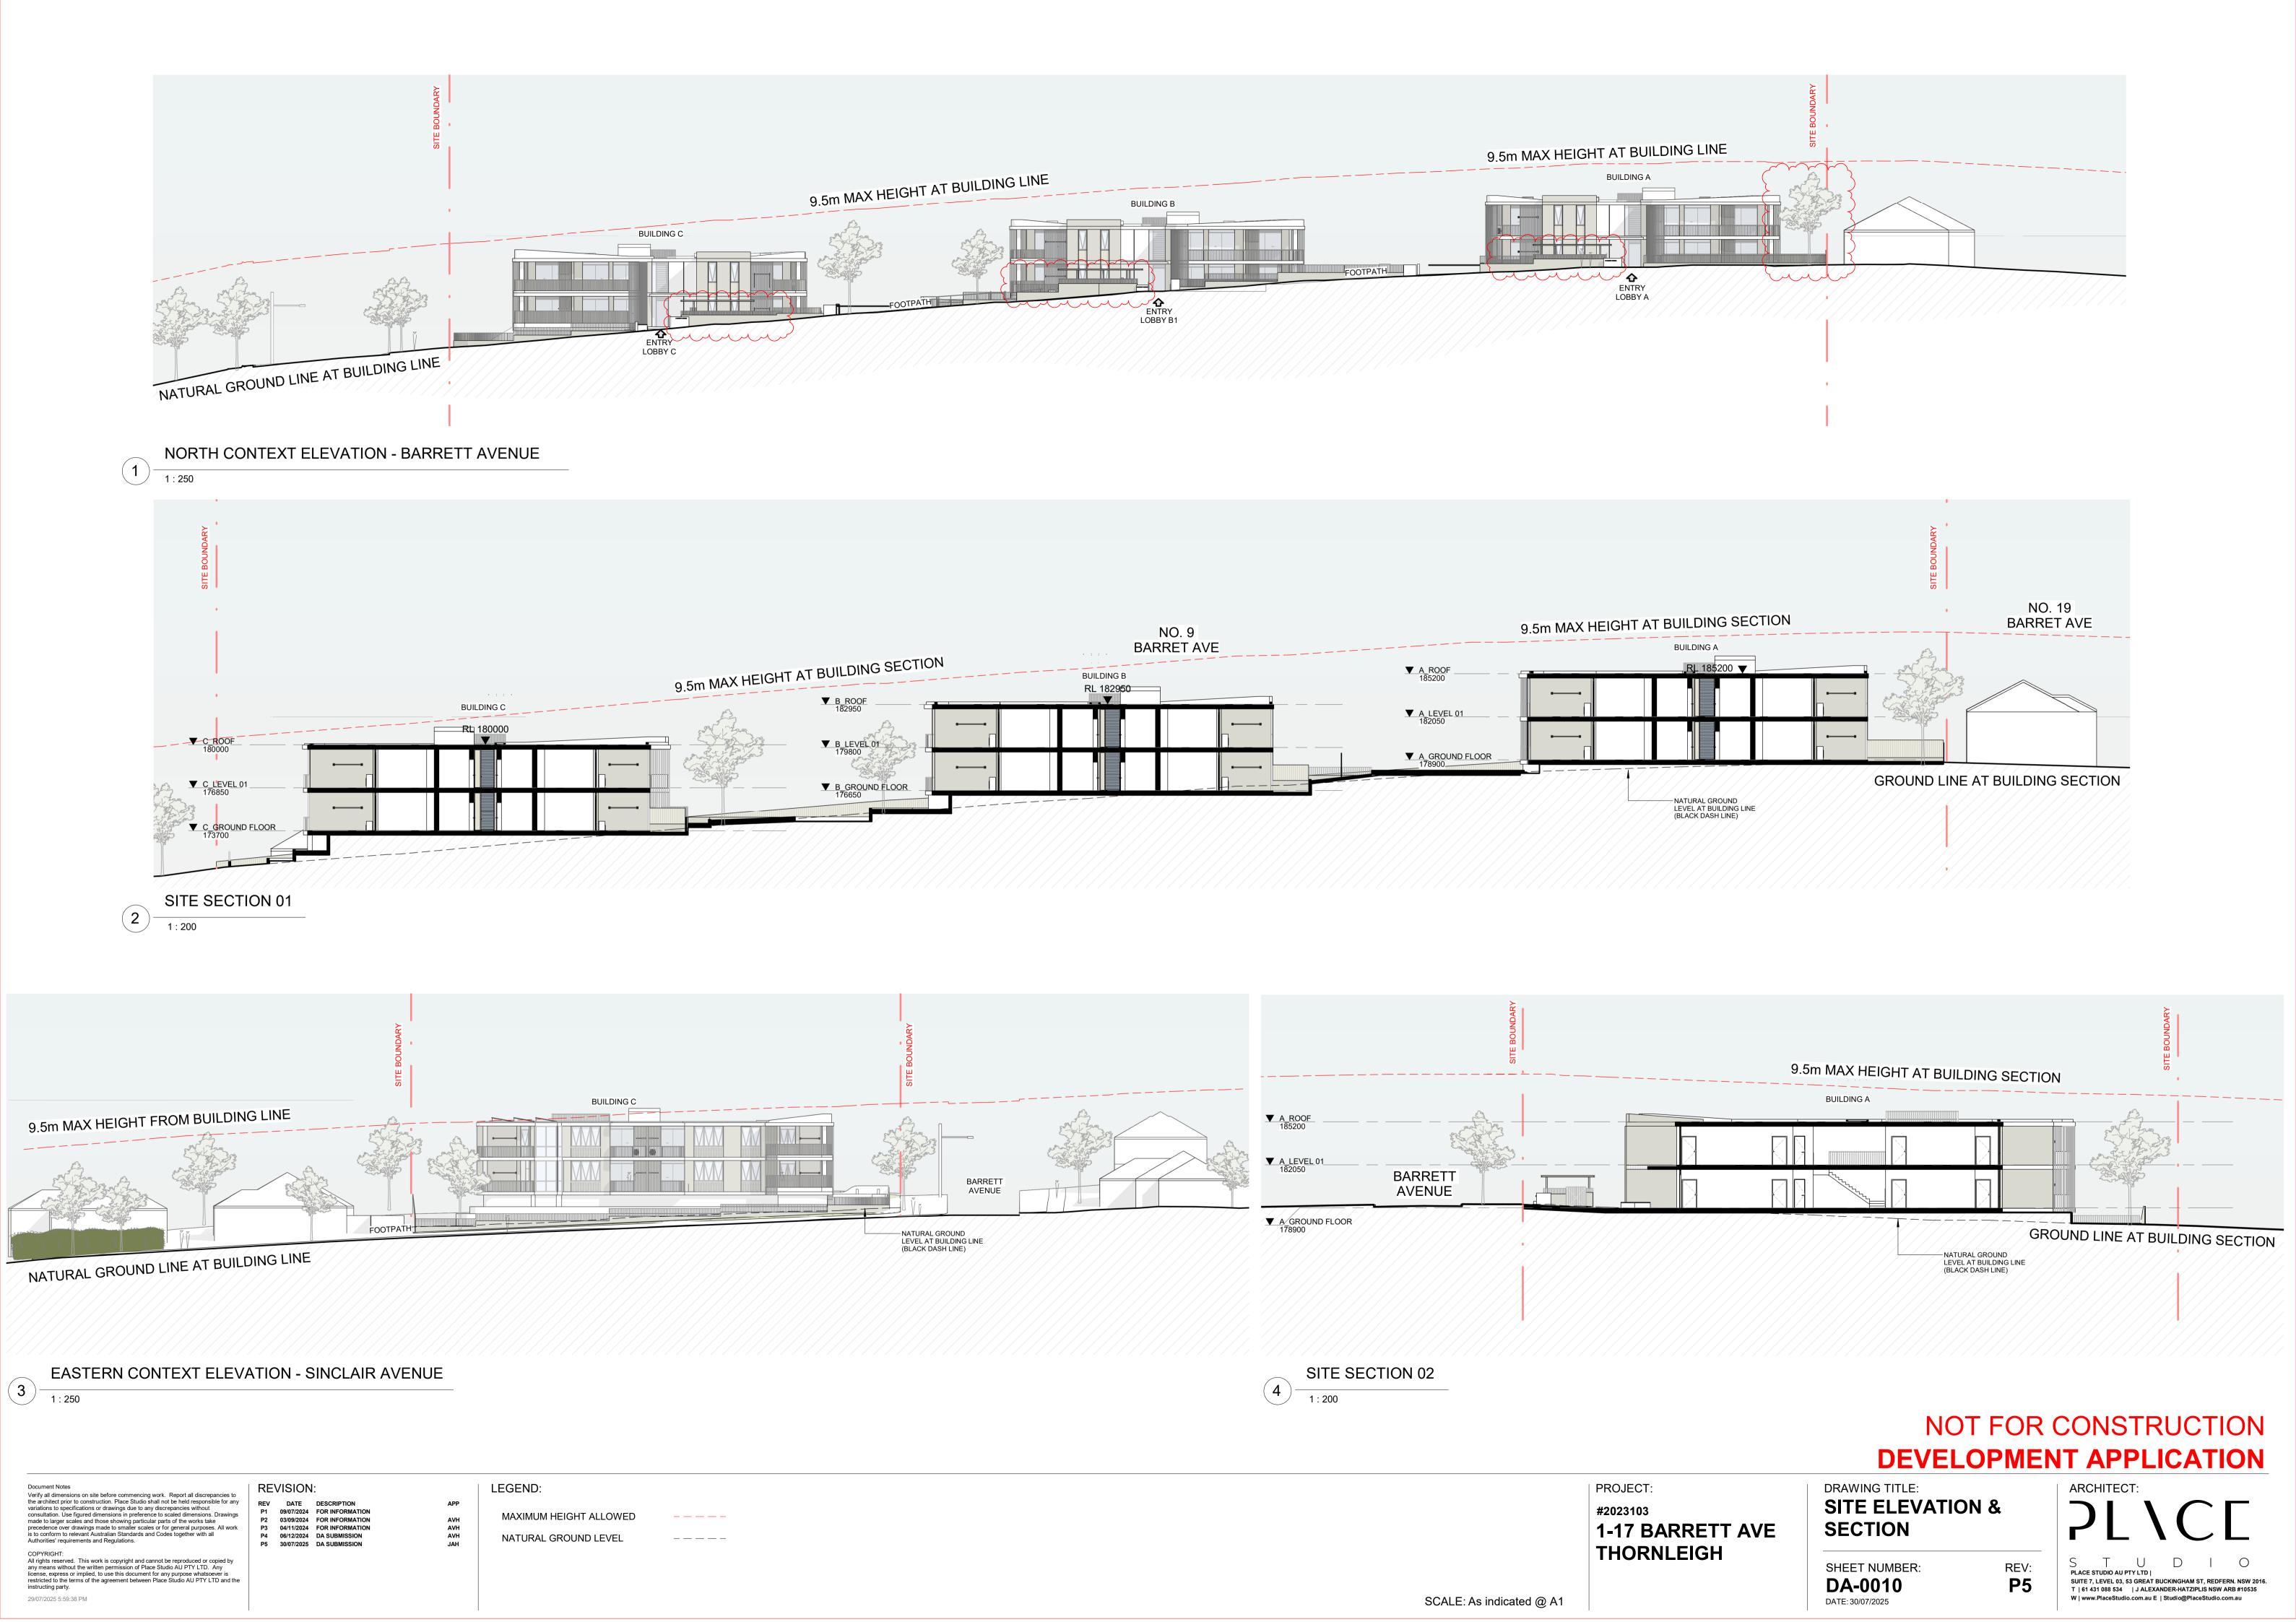
PROJECT: #2023103 1-17 BARRETT AVE **THORNLEIGH** 


DRAWING TITLE: **CUT AND FILL PLAN** 

SHEET NUMBER: **DA-0006** 

DATE: 30/07/2025

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**REVISION:** 



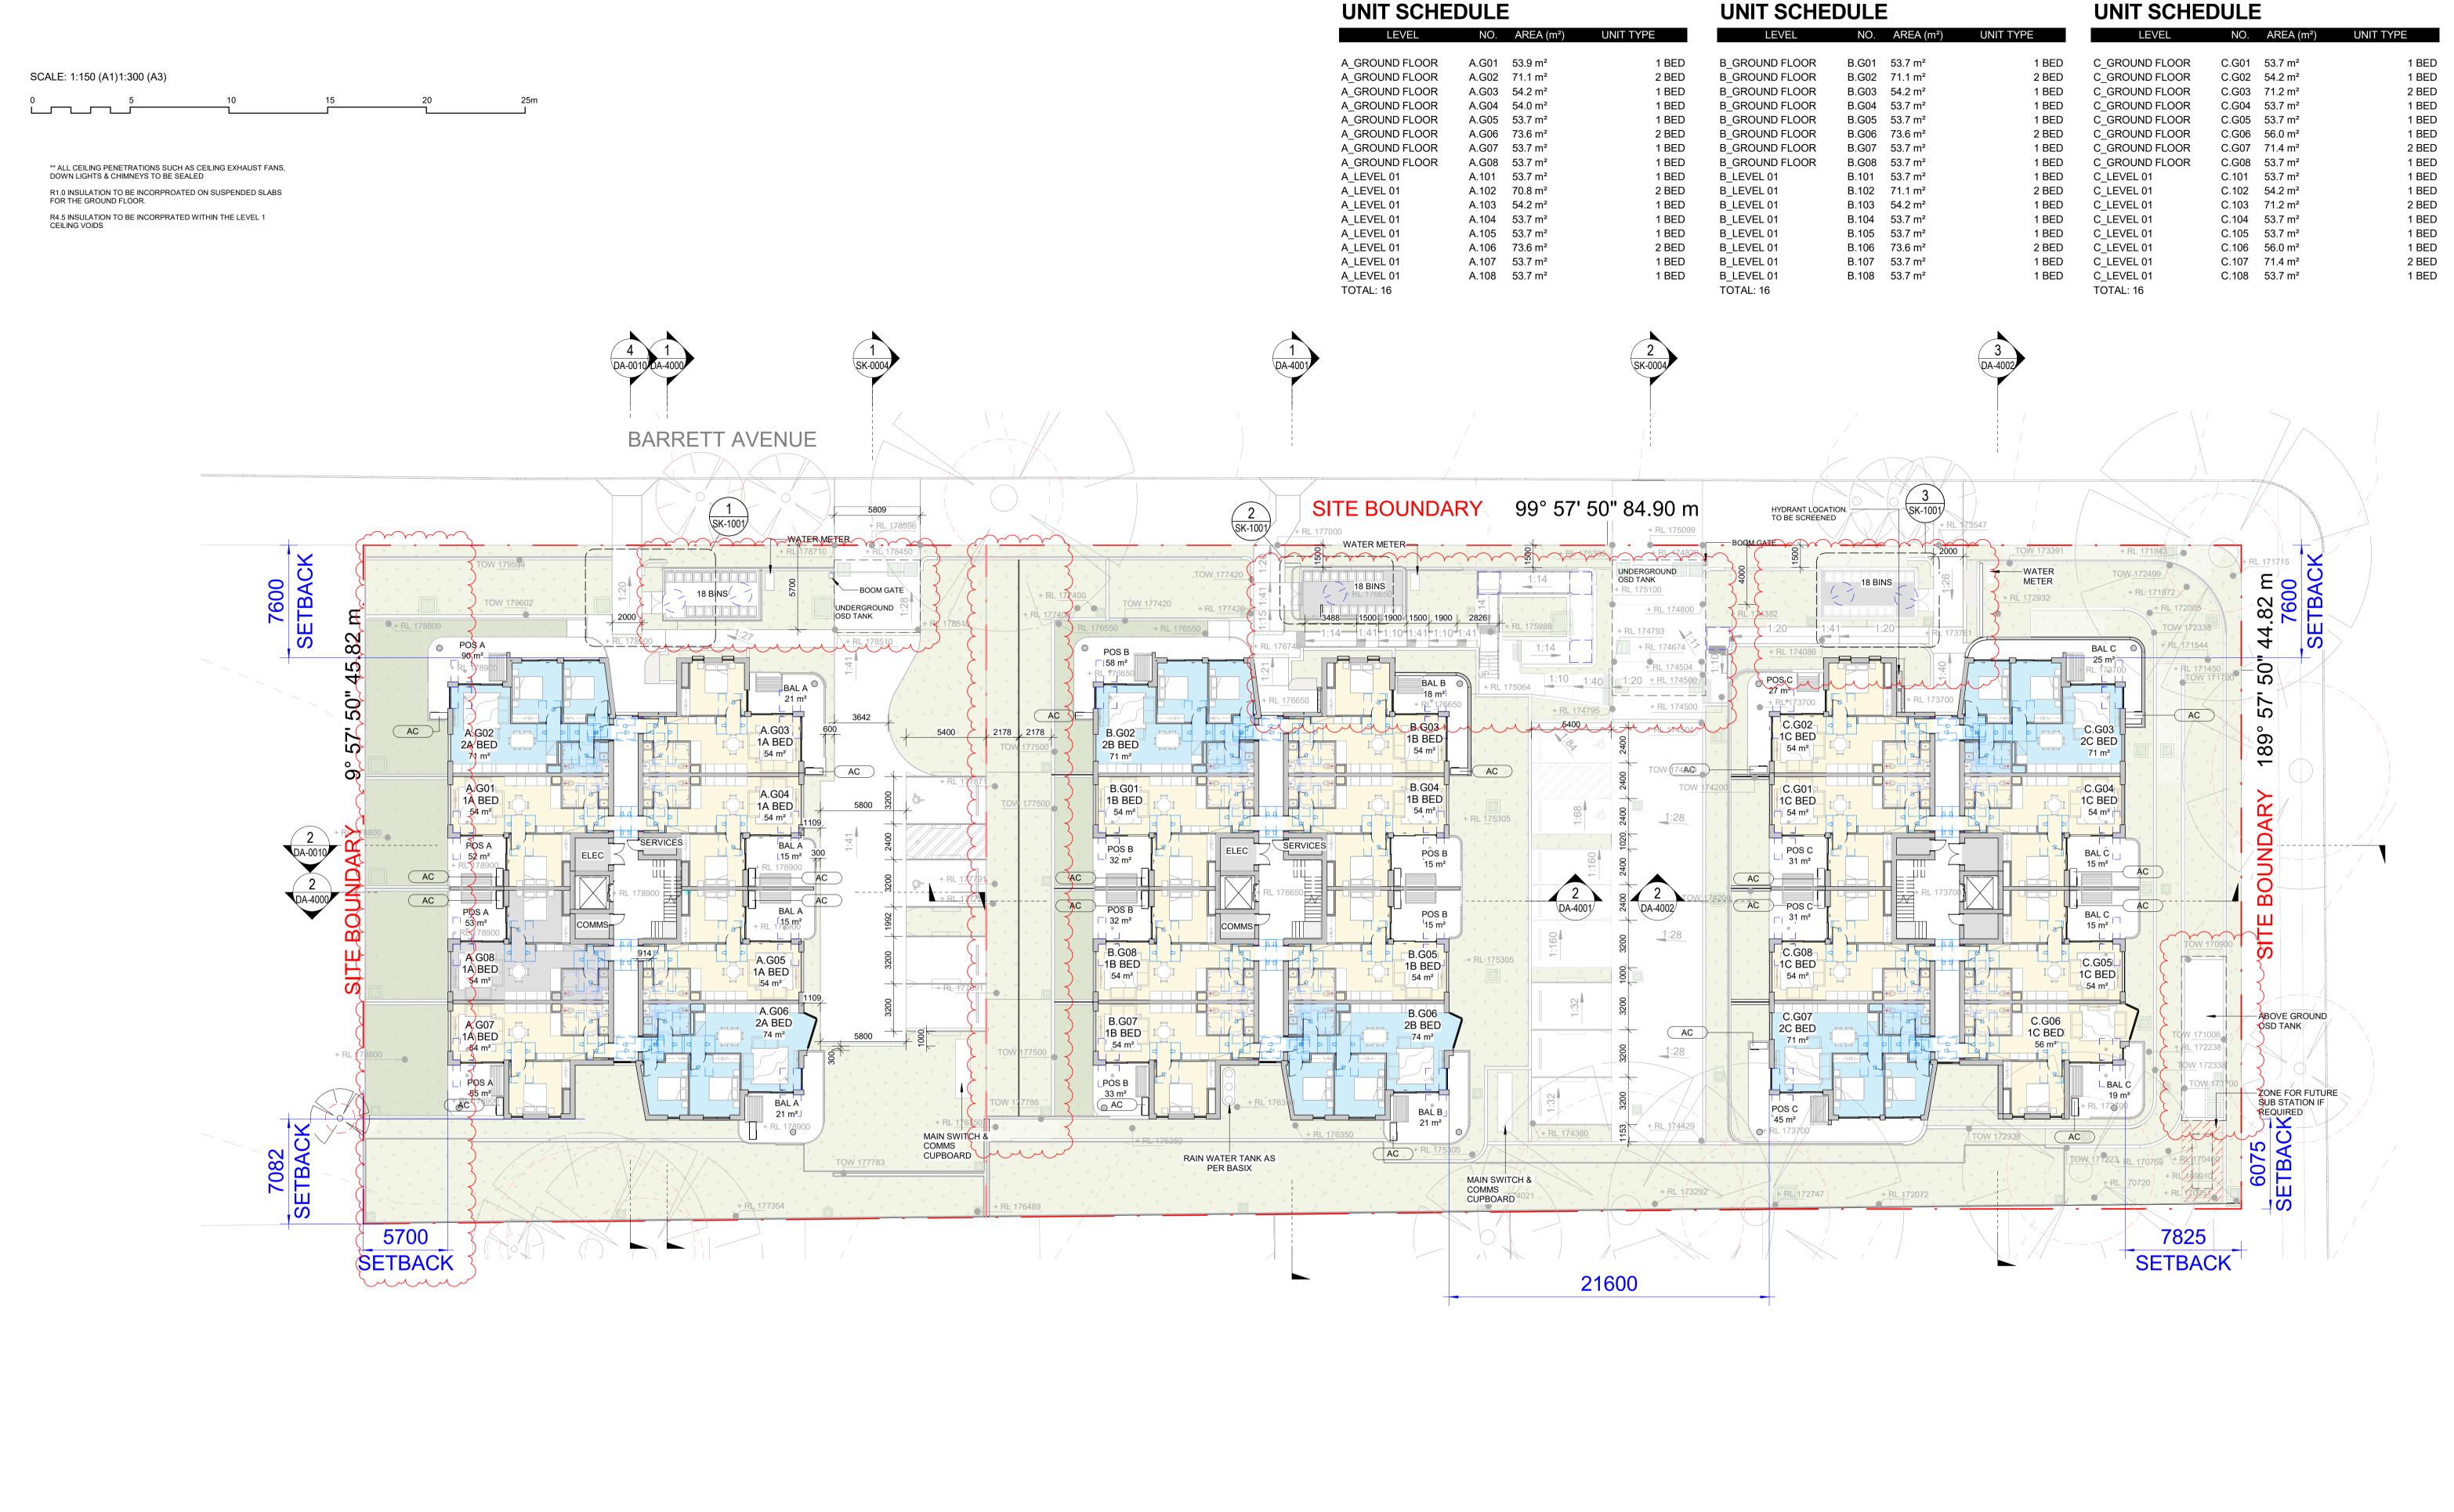

SCALE: As indicated @ A1

PROJECT: #2023103 1-17 BARRETT AVE **THORNLEIGH** 


DRAWING TITLE: **GA-GROUND FLOOR PLAN** 

SHEET NUMBER: **DA-2000** 

DATE: 30/07/2025

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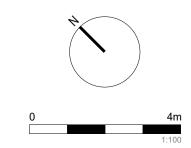
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LEGEND:

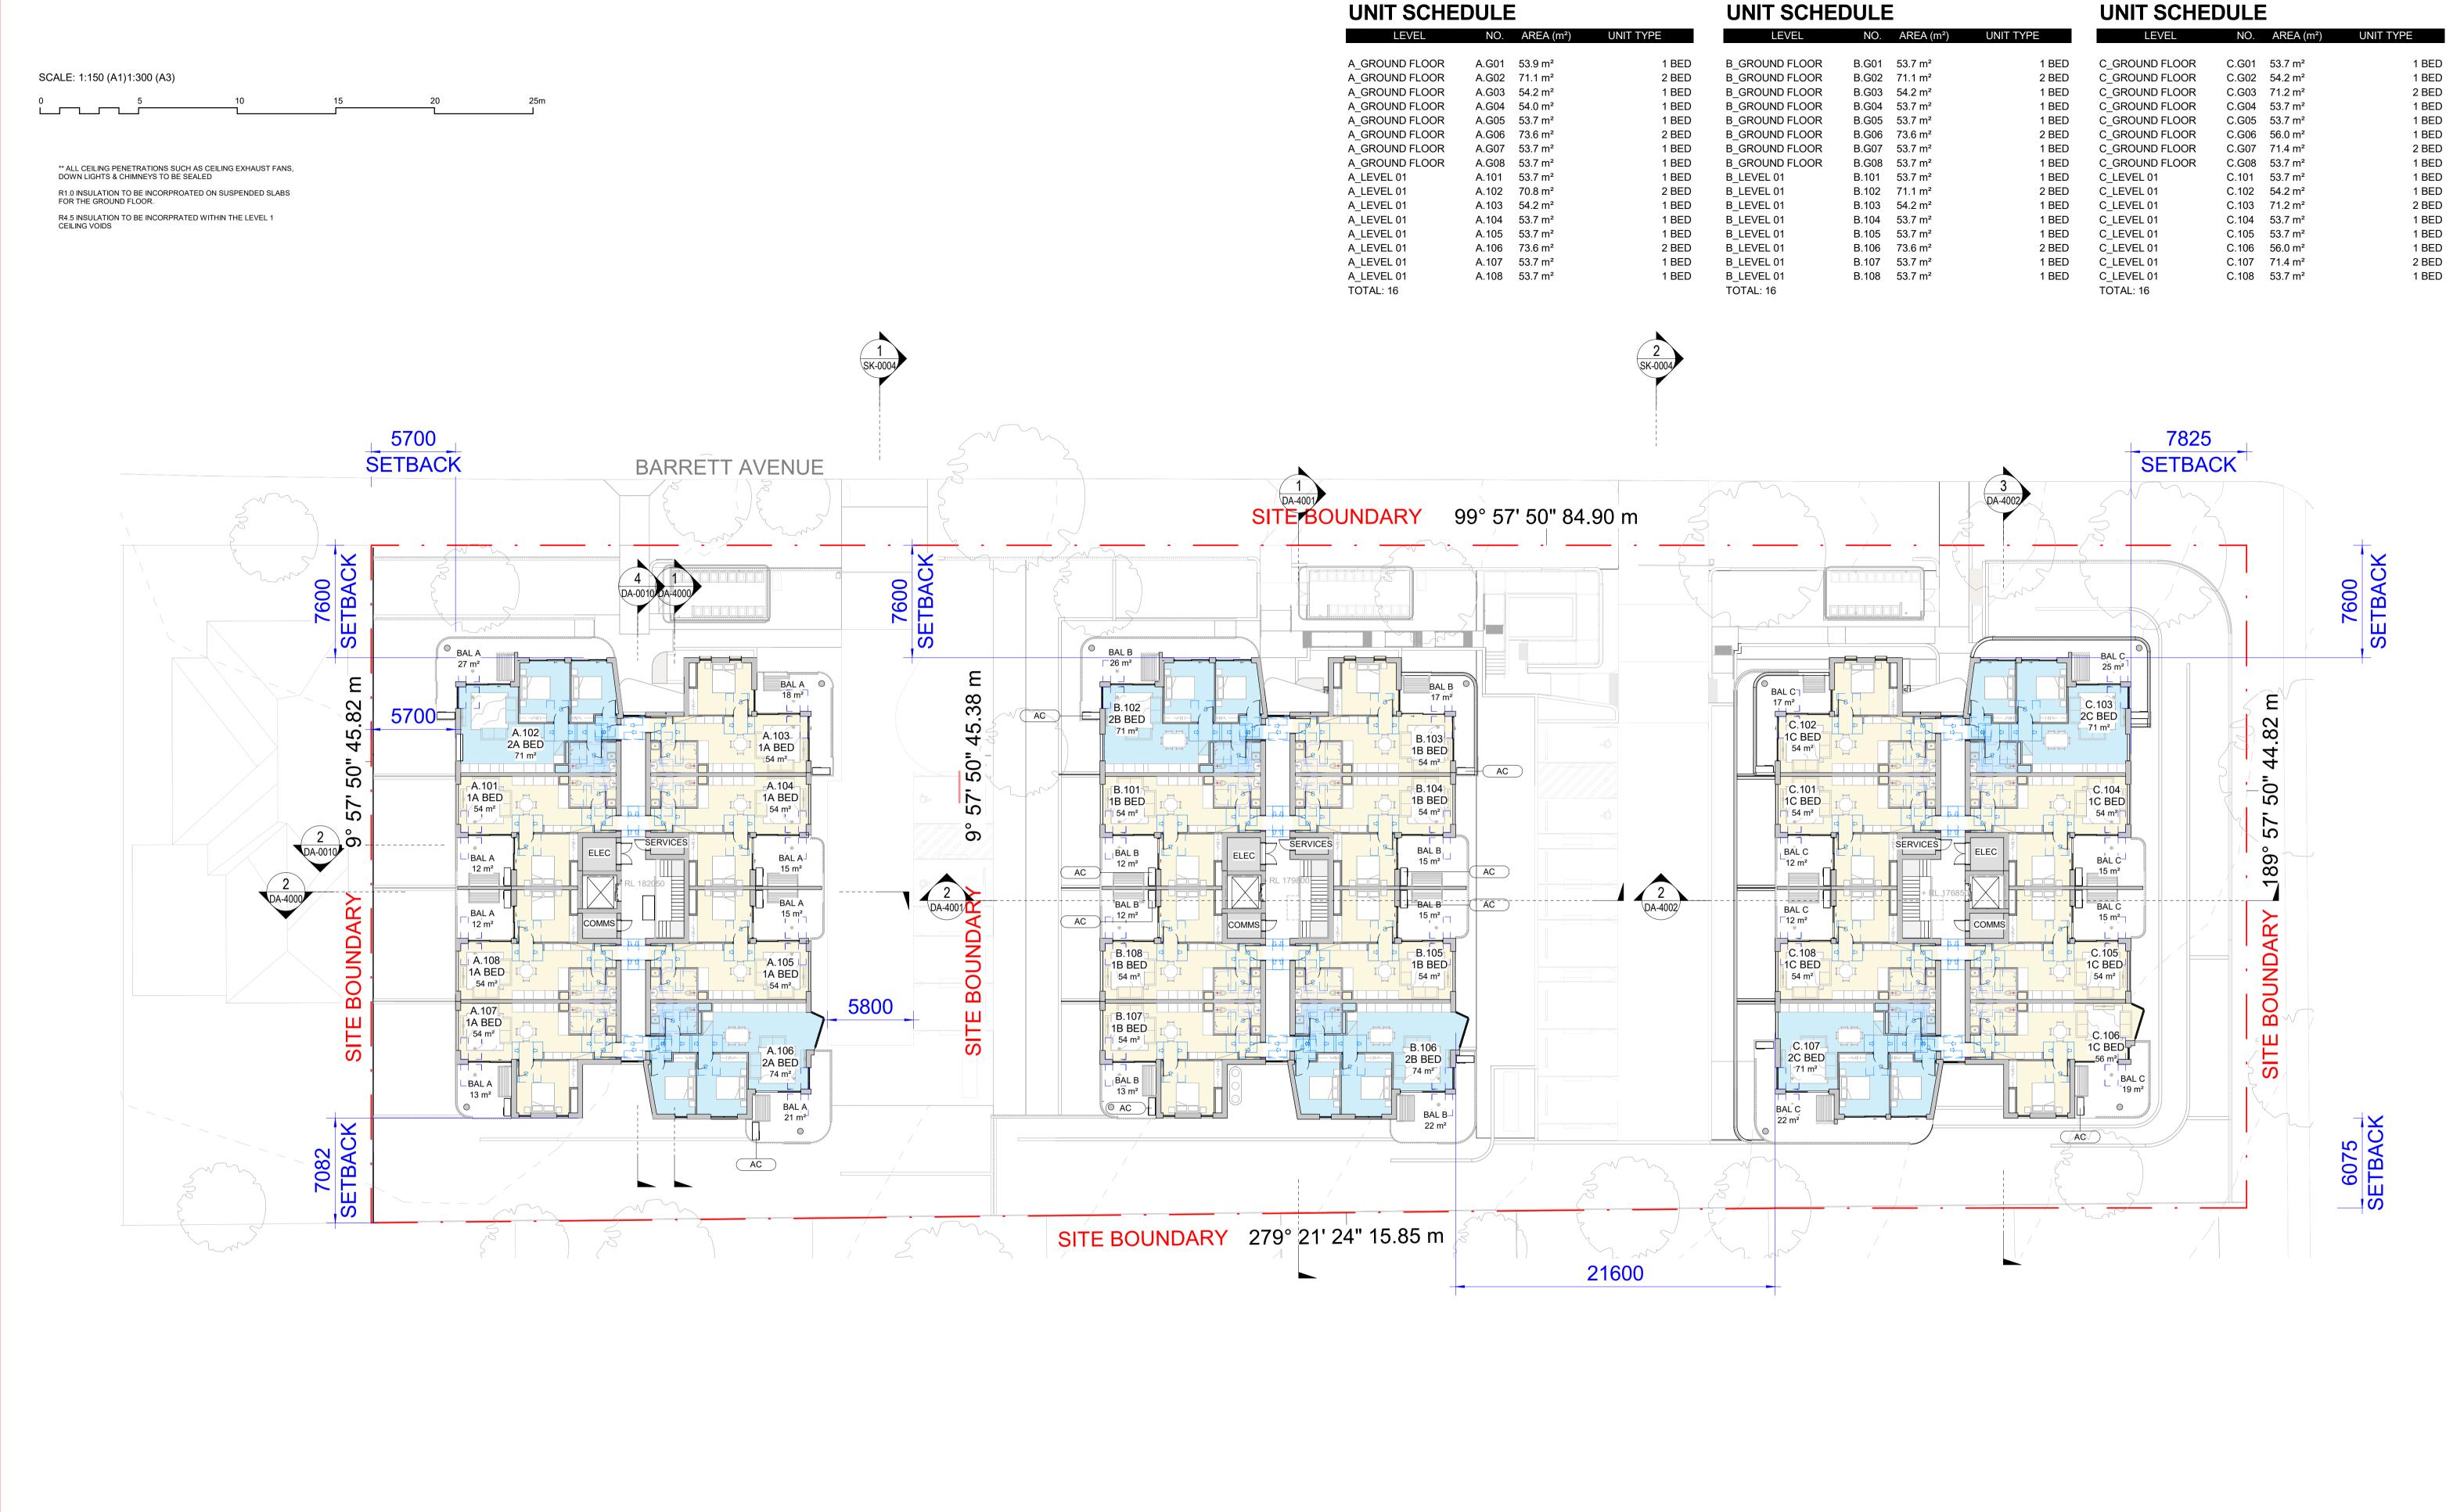

SCALE: As indicated @ A1

#2023103 1-17 BARRETT AVE **THORNLEIGH** 

PROJECT:

DRAWING TITLE: **GA-LEVEL 01 PLAN** 

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SHEET NUMBER: **DA-2001** DATE: 30/07/2025

\*\* ALL CEILING PENETRATIONS SUCH AS CEILING EXHAUST FANS, DOWN LIGHTS & CHIMNEYS TO BE SEALED R1.0 INSULATION TO BE INCORPROATED ON SUSPENDED SLABS FOR THE GROUND FLOOR. R4.5 INSULATION TO BE INCORPRATED WITHIN THE LEVEL 1 CEILING VOIDS



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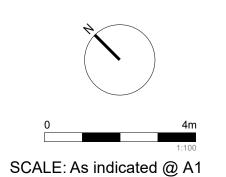
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LEGEND:



PROJECT: #2023103 1-17 BARRETT AVE THORNLEIGH

DRAWING TITLE: **GA-ROOF PLAN** 

SHEET NUMBER:


**DA-2002** 

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REV DATE DESCRIPTION
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#2023103

1-17 BARRETT AVE
THORNLEIGH

ACCESS - SITE A -GROUND FLOOR PLAN

SHEET NUMBER: REV
DA-2100 P2

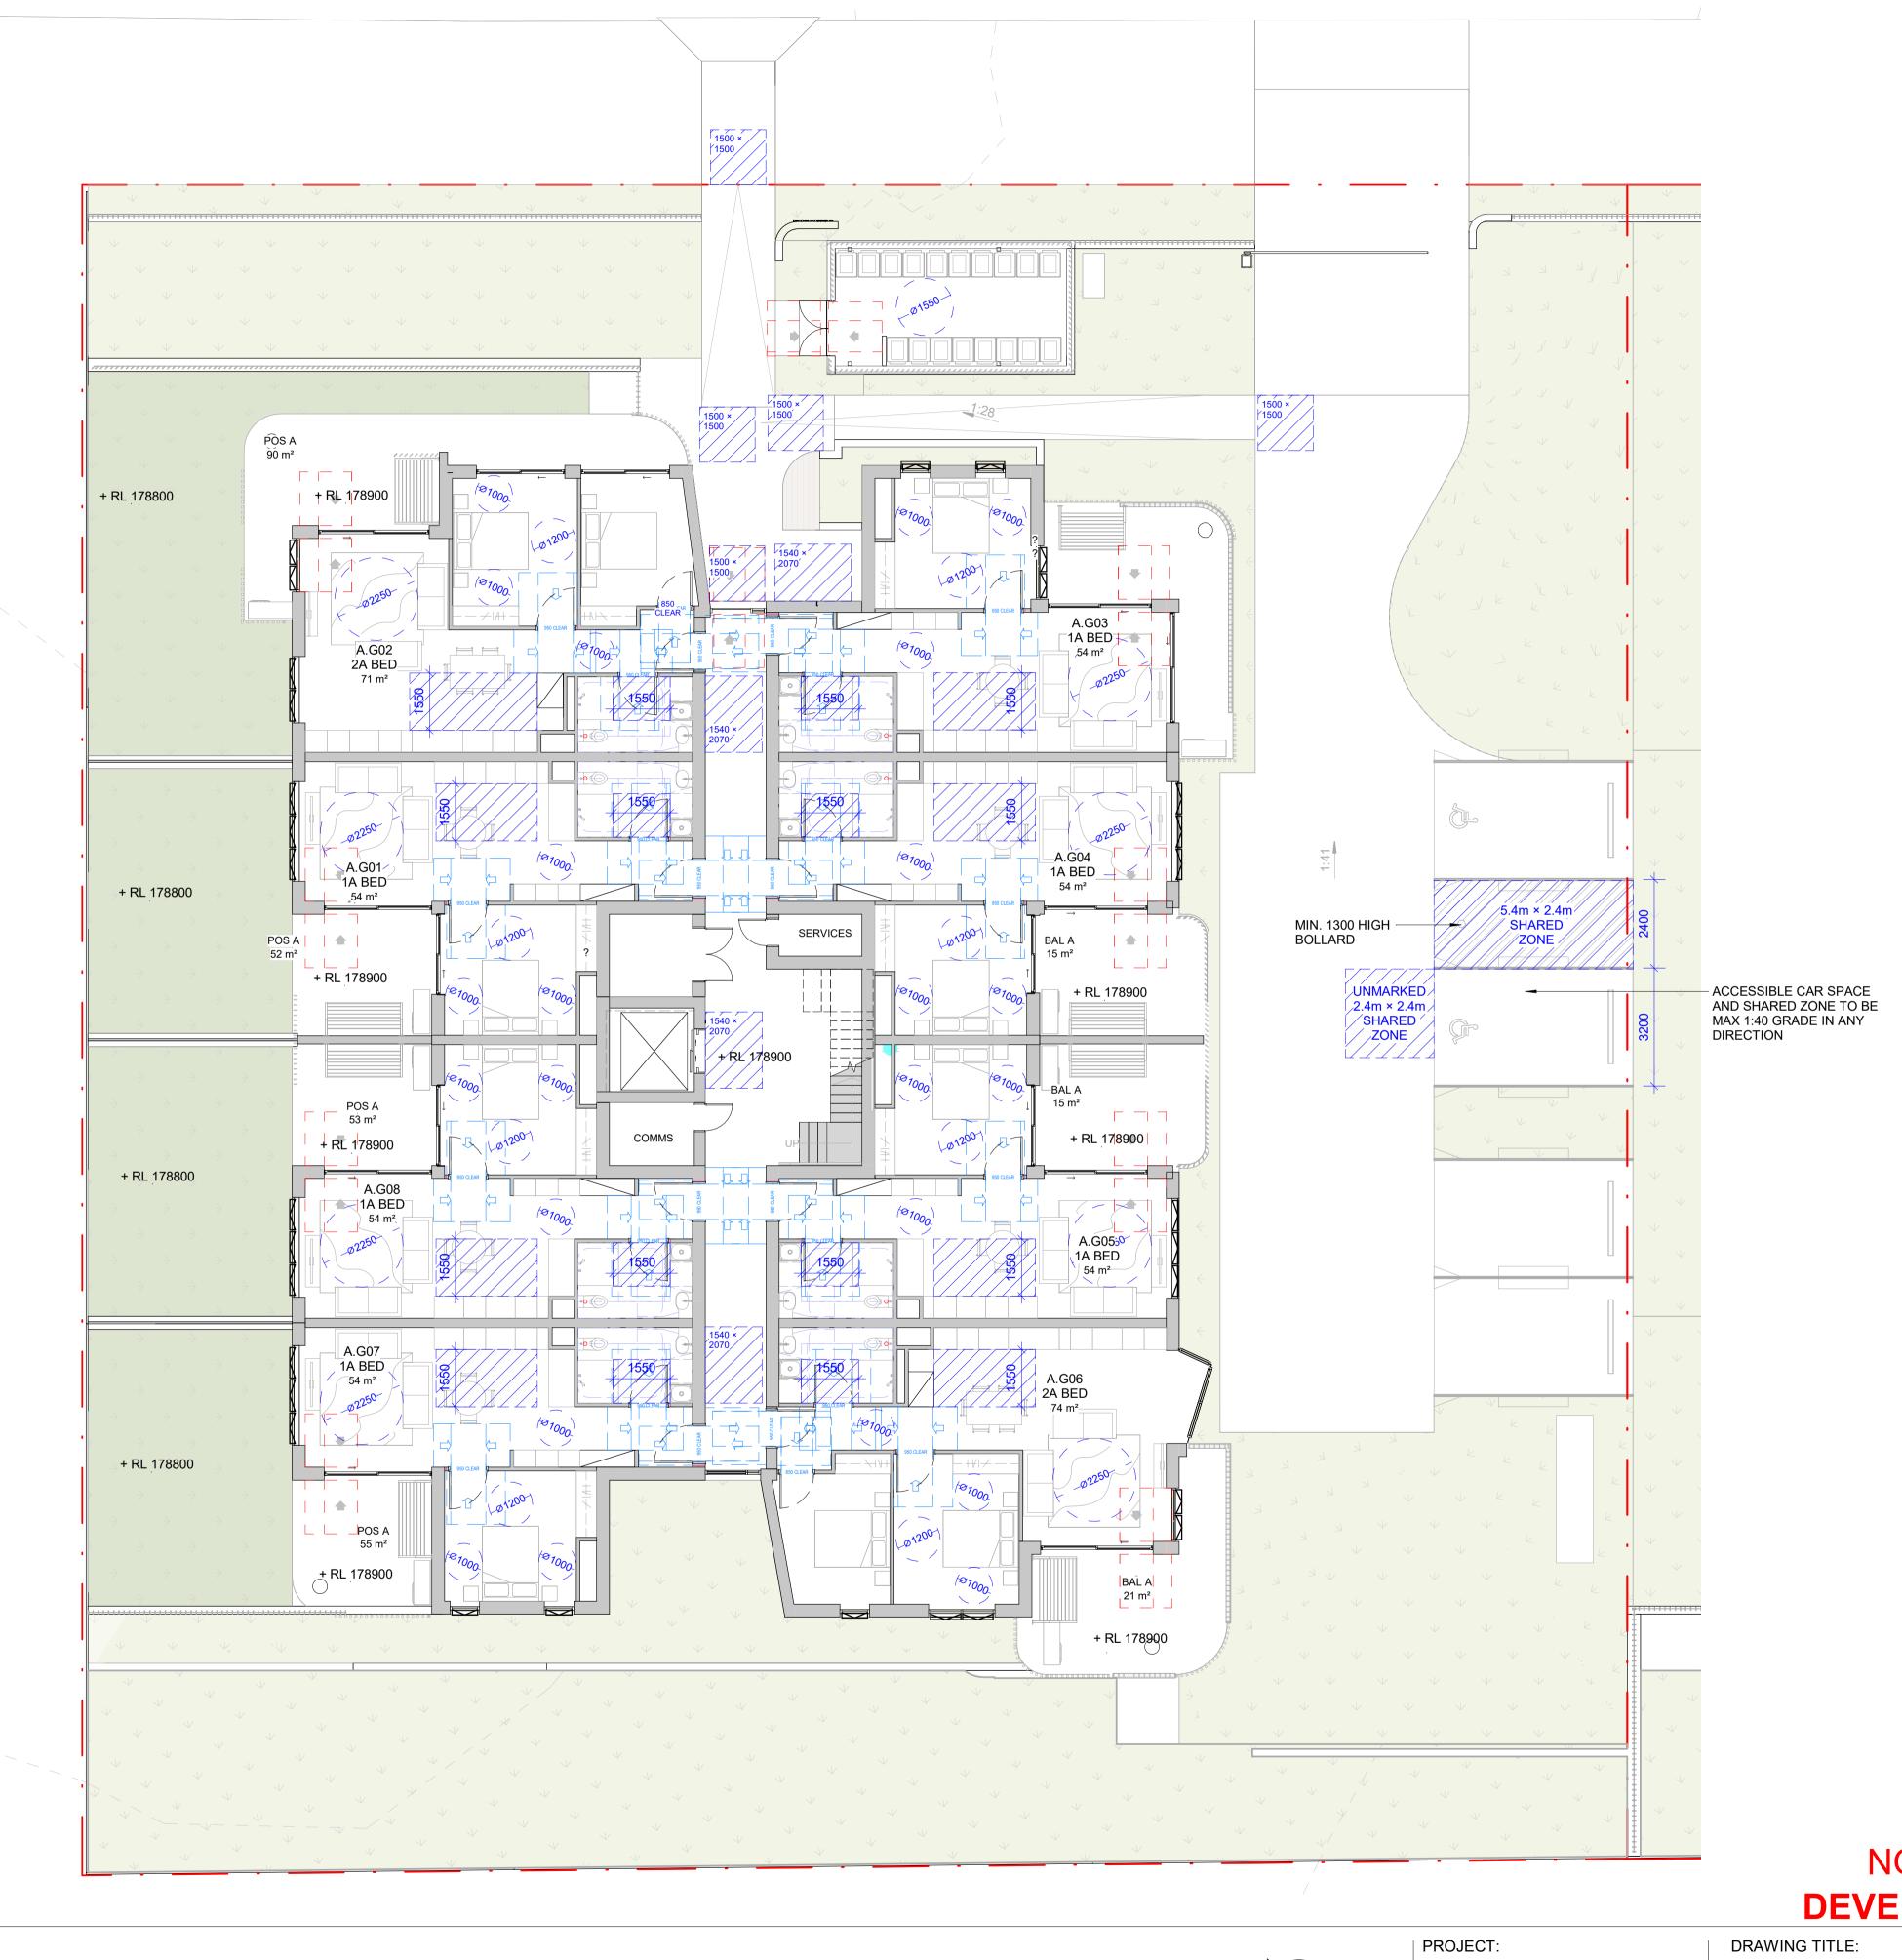DATE: 30/07/2025





| PROJECT:

SCALE: 1:100 @ A0 CLIENT: LINKWENTWORTH

DATE: 30/07/2025



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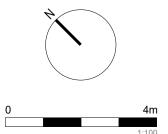
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 P1
 06/12/2024
 DA SUBMISSION

 P2
 30/07/2025
 DA SUBMISSION

LEGEND:



#2023103

1-17 BARRETT AVE THORNLEIGH

DRAWING TITLE: ACCESS - SITE A -**LEVEL 01 PLAN** 

SHEET NUMBER: DA-2103

DATE: 30/07/2025

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DA-2104

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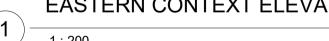
| PROJECT:

SCALE: 1:100 @ A0 CLIENT: LINKWENTWORTH



NORTH CONTEXT ELEVATION - BARRETT AVENUE 2







**CF1** - FIBRE CEMENT BARESTONE CEMINTEL



CF2 - C2 CONCRETE FINISH



**BR1** - BRICK FINISH BOTANICALS JUNIPER PGH BRICKS OR SIMILAR

**BR2** - STAGGERED BRICK

DETAILING



PT1 - POWDERCOAT BRONZE (WINDOW FRAMES, BALUSTRADES & SCREENS)



PT2 - PAINT FINISH - GREY

SCALE: As indicated @ A1



**ST1** - RETAINING CONCRETE BLOCKS OR SIMILAR

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LEGEND:

MAXIMUM HEIGHT ALLOWED NATURAL GROUND LEVEL

\_ \_ \_ \_ \_




PROJECT: #2023103 1-17 BARRETT AVE **THORNLEIGH** 

DRAWING TITLE: STREETSCAPE **ELEVATIONS** 

DATE: 30/07/2025

SHEET NUMBER: DA-3000

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A - NORTHERN ELEVATION

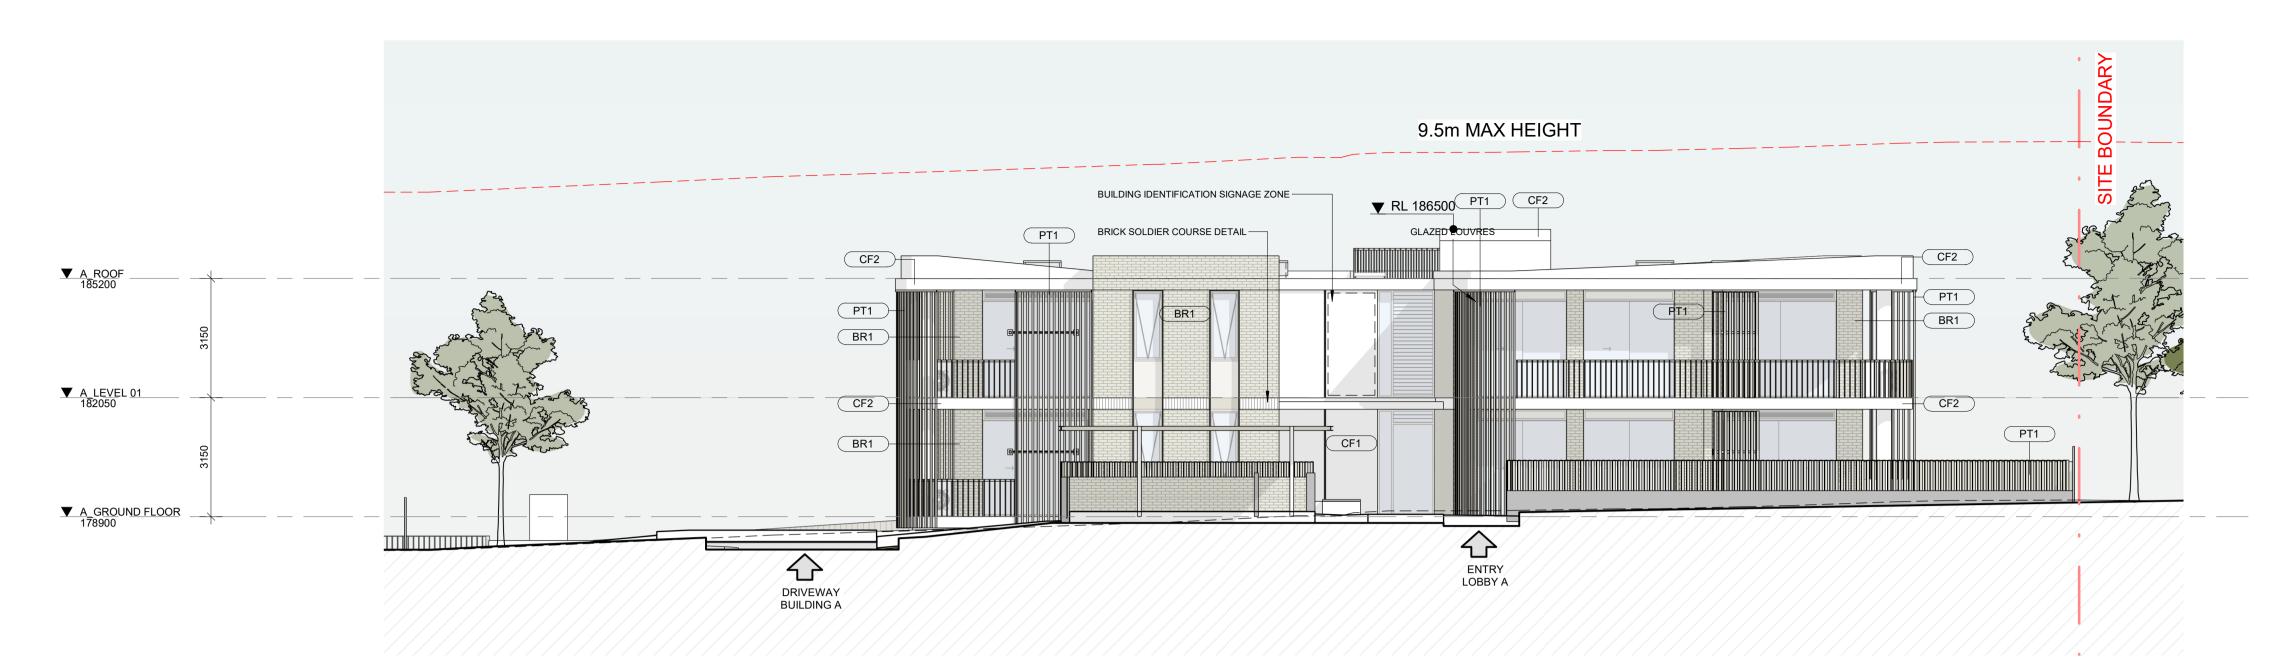

A - SOUTHERN ELEVATION 1:100



**CF1** - FIBRE CEMENT BARESTONE CEMINTEL



CF2 - C2 CONCRETE FINISH



**BR1** - BRICK FINISH **BOTANICALS JUNIPER** PGH BRICKS OR SIMILAR

DETAILING

**BR2** - STAGGERED BRICK



PT1 - POWDERCOAT BRONZE (WINDOW FRAMES, BALUSTRADES & SCREENS)



PT2 - PAINT FINISH - GREY



**ST1** - RETAINING CONCRETE BLOCKS OR SIMILAR

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LEGEND:

MAXIMUM HEIGHT ALLOWED NATURAL GROUND LEVEL

\_ \_ \_ \_ \_




PROJECT: #2023103 1-17 BARRETT AVE **THORNLEIGH** 

DRAWING TITLE: **BUILDING ELEVATIONS** 

SHEET NUMBER: REV: **DA-3002** DATE: 30/07/2025





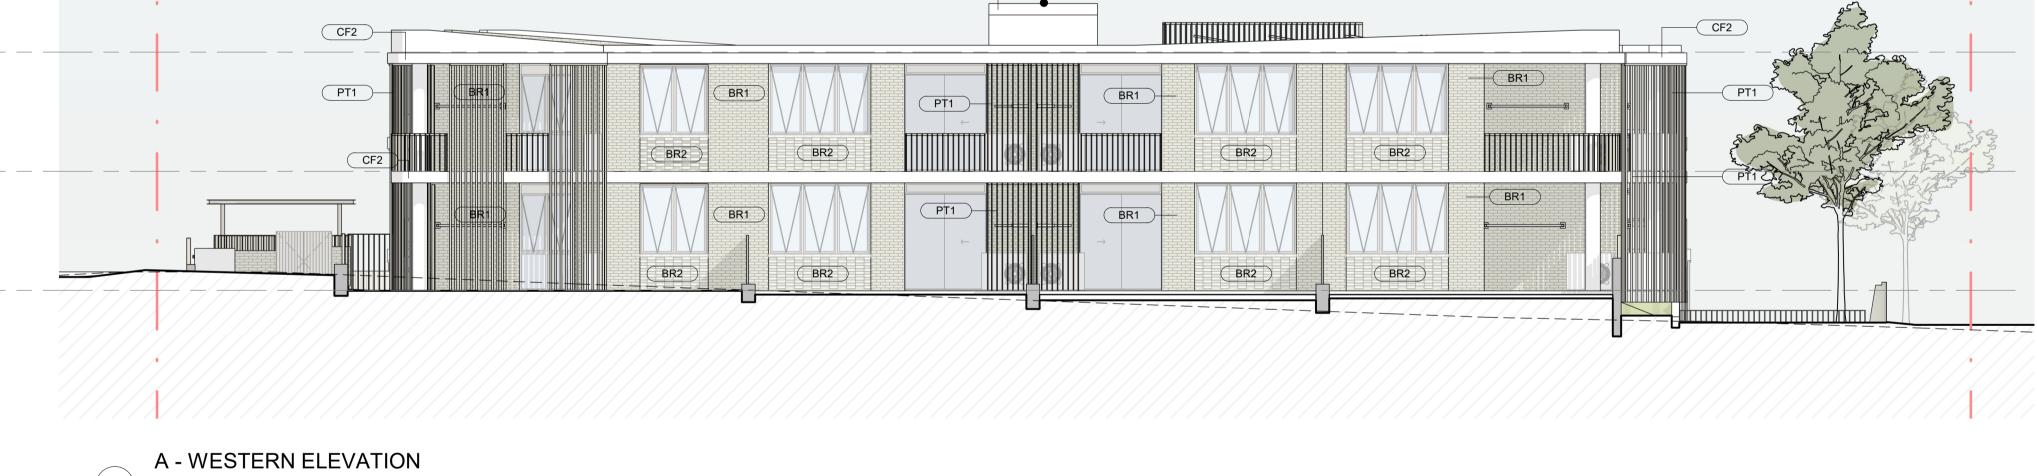



**CF1** - FIBRE CEMENT BARESTONE CEMINTEL

▼ A\_LEVEL 01 182050

▼ A\_GROUND FLOOR



CF2 - C2 CONCRETE FINISH



**BR1** - BRICK FINISH **BOTANICALS JUNIPER** PGH BRICKS OR SIMILAR

DETAILING

**BR2** - STAGGERED BRICK



PT1 - POWDERCOAT BRONZE (WINDOW FRAMES, BALUSTRADES & SCREENS)



PT2 - PAINT FINISH - GREY



**ST1** - RETAINING CONCRETE BLOCKS OR SIMILAR

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LEGEND:

MAXIMUM HEIGHT ALLOWED NATURAL GROUND LEVEL

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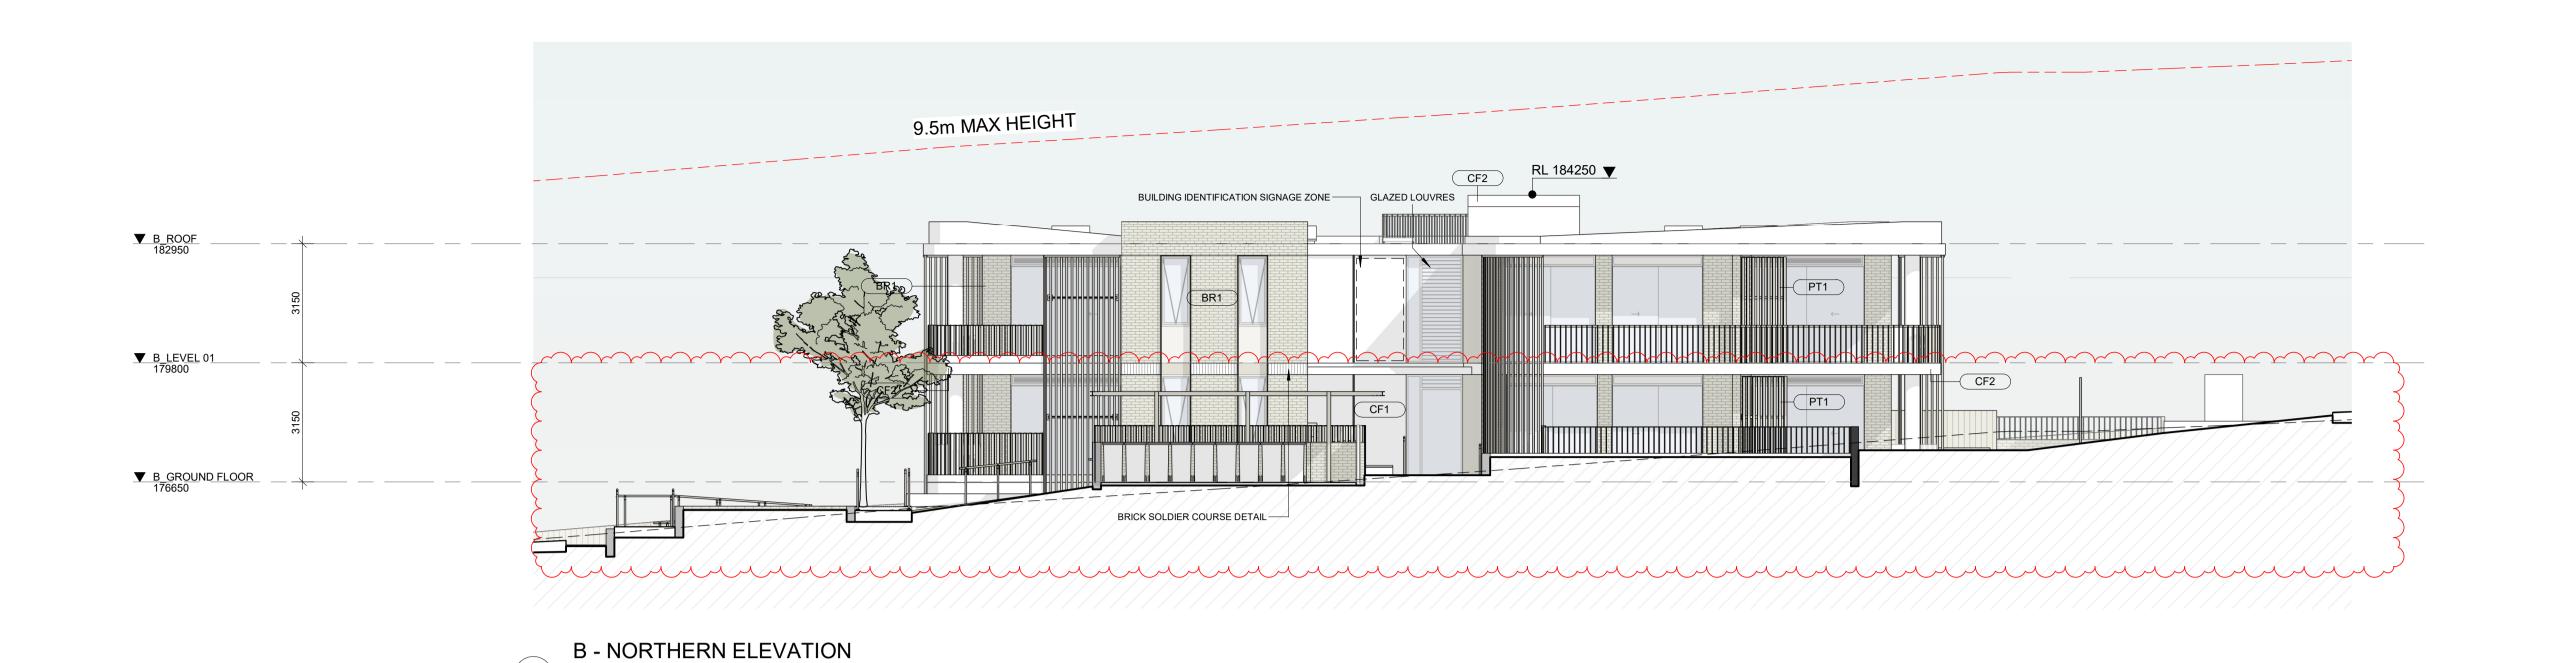


PROJECT: #2023103 1-17 BARRETT AVE **THORNLEIGH** 

DRAWING TITLE: **BUILDING ELEVATIONS** 

SHEET NUMBER: REV: **DA-3003** DATE: 30/07/2025











**CF1** - FIBRE CEMENT BARESTONE CEMINTEL



CF2 - C2 CONCRETE FINISH



**BR1** - BRICK FINISH **BOTANICALS JUNIPER** PGH BRICKS OR SIMILAR

**BR2** - STAGGERED BRICK

DETAILING



PT1 - POWDERCOAT BRONZE (WINDOW FRAMES, BALUSTRADES & SCREENS)



PT2 - PAINT FINISH - GREY



**ST1** - RETAINING CONCRETE BLOCKS OR SIMILAR

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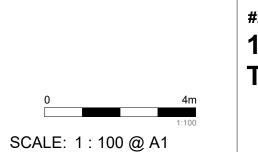
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LEGEND:

MAXIMUM HEIGHT ALLOWED NATURAL GROUND LEVEL

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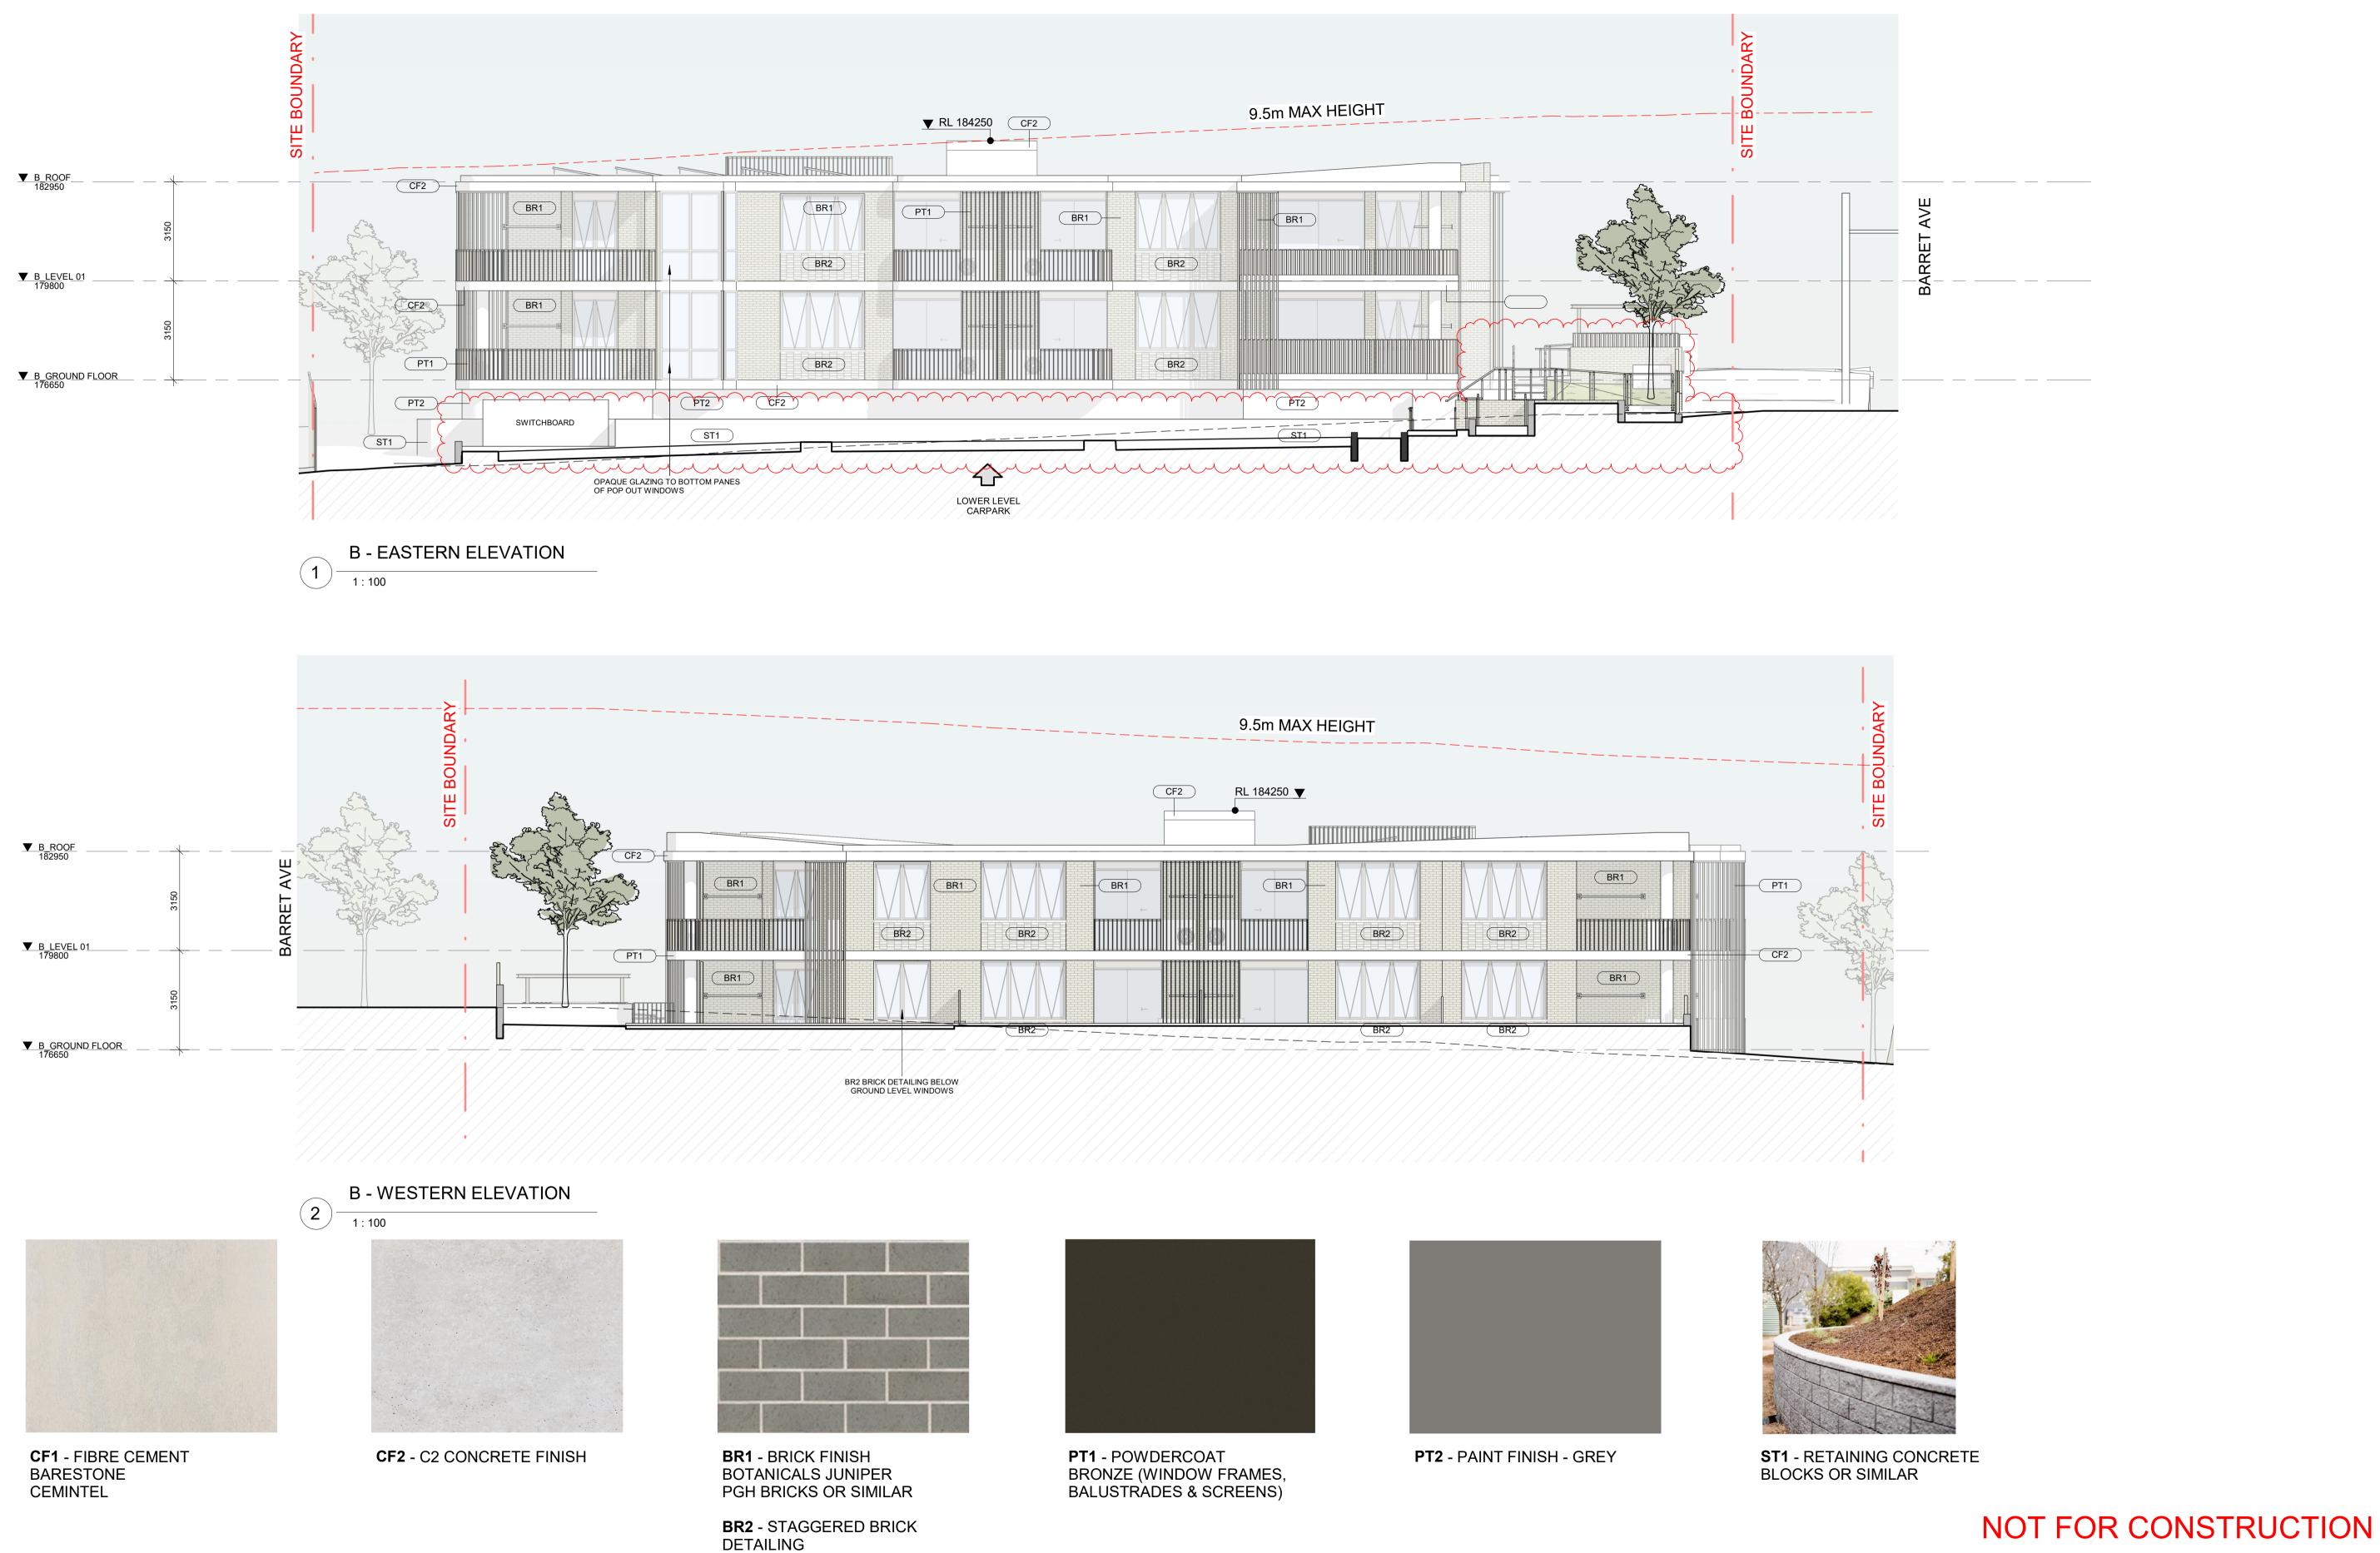


PROJECT: #2023103 1-17 BARRETT AVE **THORNLEIGH** 

DRAWING TITLE: **BUILDING ELEVATIONS** 

SHEET NUMBER: REV: **DA-3004** DATE: 30/07/2025





**DEVELOPMENT APPLICATION** PROJECT: DRAWING TITLE: ARCHITECT:

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LEGEND:

MAXIMUM HEIGHT ALLOWED NATURAL GROUND LEVEL

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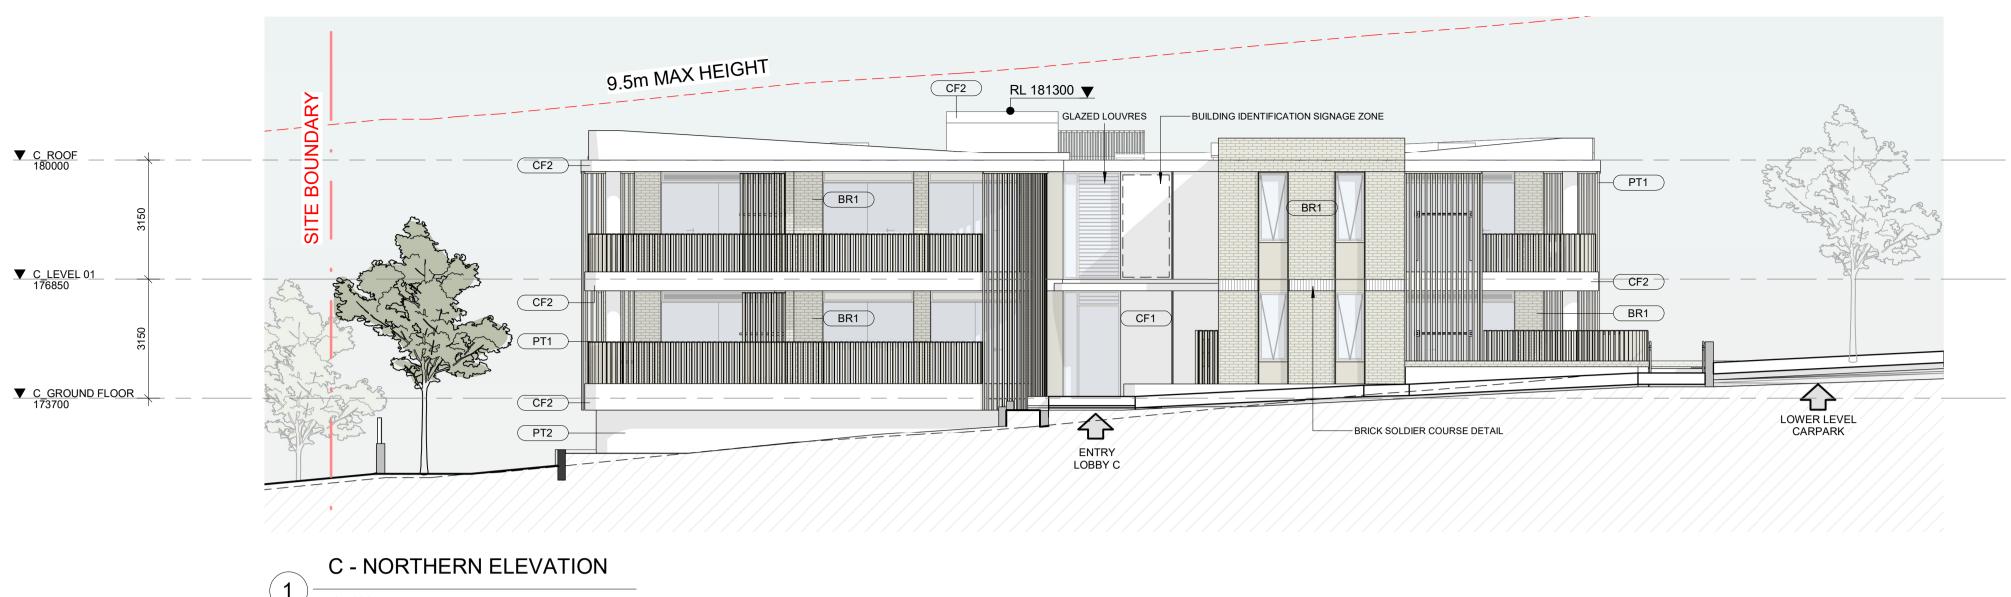
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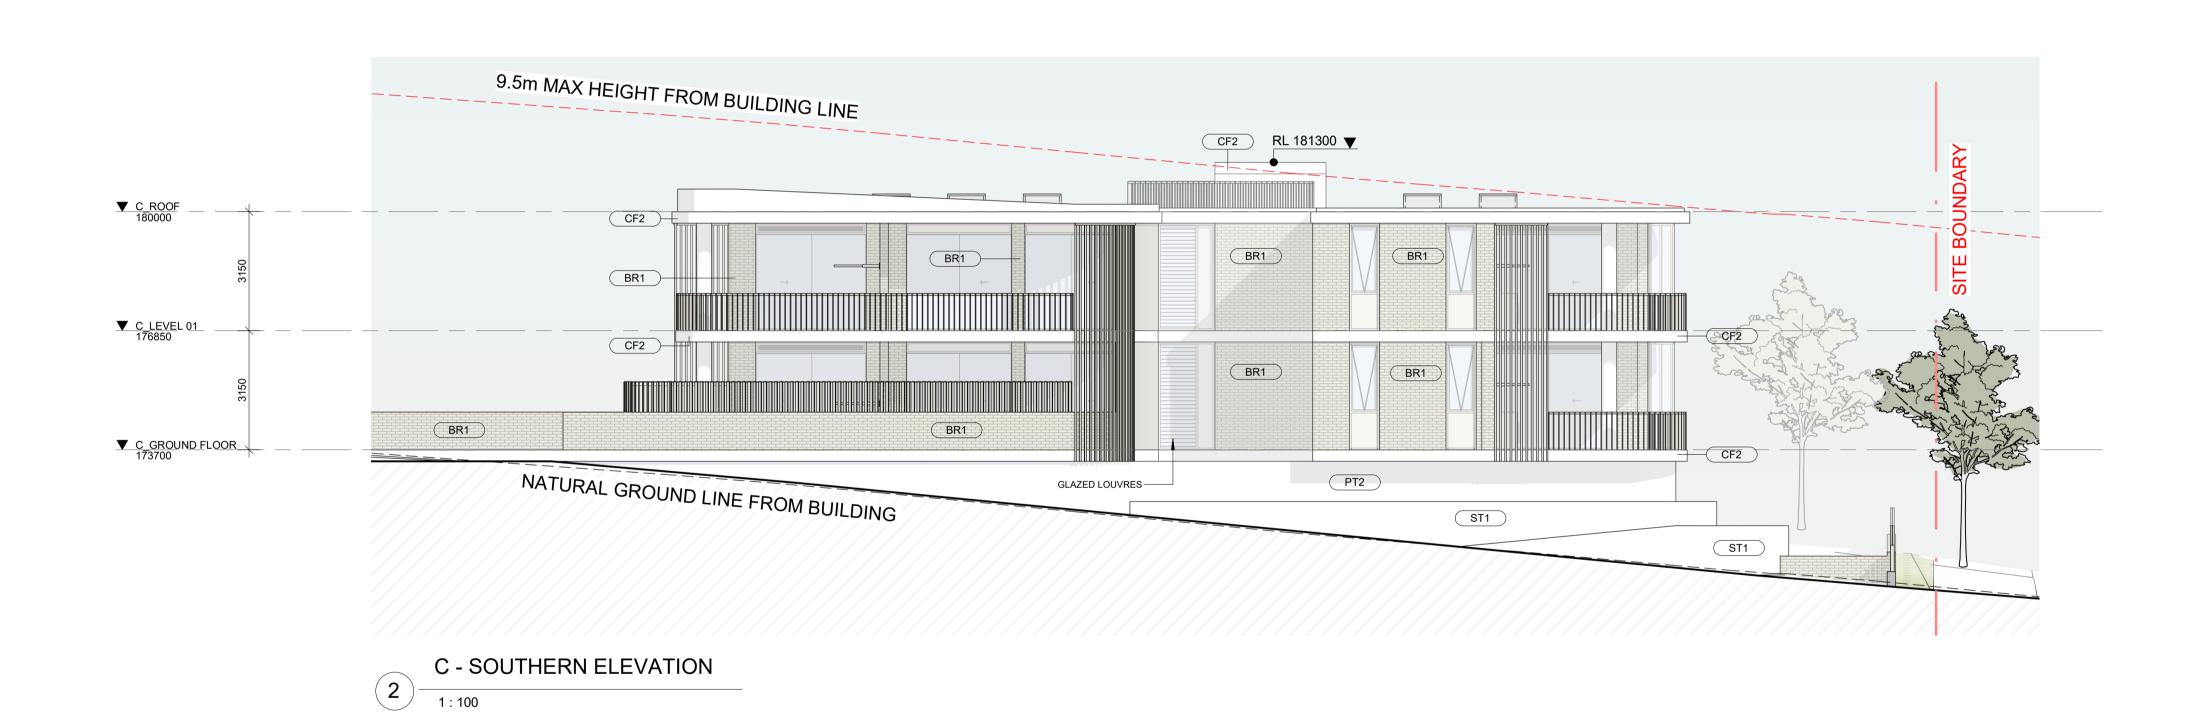
#2023103 1-17 BARRETT AVE **THORNLEIGH** 

**BUILDING ELEVATIONS** 

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CF2 - C2 CONCRETE FINISH



**BR1** - BRICK FINISH **BOTANICALS JUNIPER** PGH BRICKS OR SIMILAR

**BR2** - STAGGERED BRICK

**DETAILING** 



**PT1** - POWDERCOAT BRONZE (WINDOW FRAMES, BALUSTRADES & SCREENS)



PT2 - PAINT FINISH - GREY



**ST1** - RETAINING CONCRETE BLOCKS OR SIMILAR

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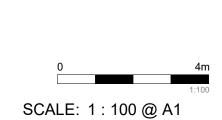
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MAXIMUM HEIGHT ALLOWED NATURAL GROUND LEVEL

LEGEND:

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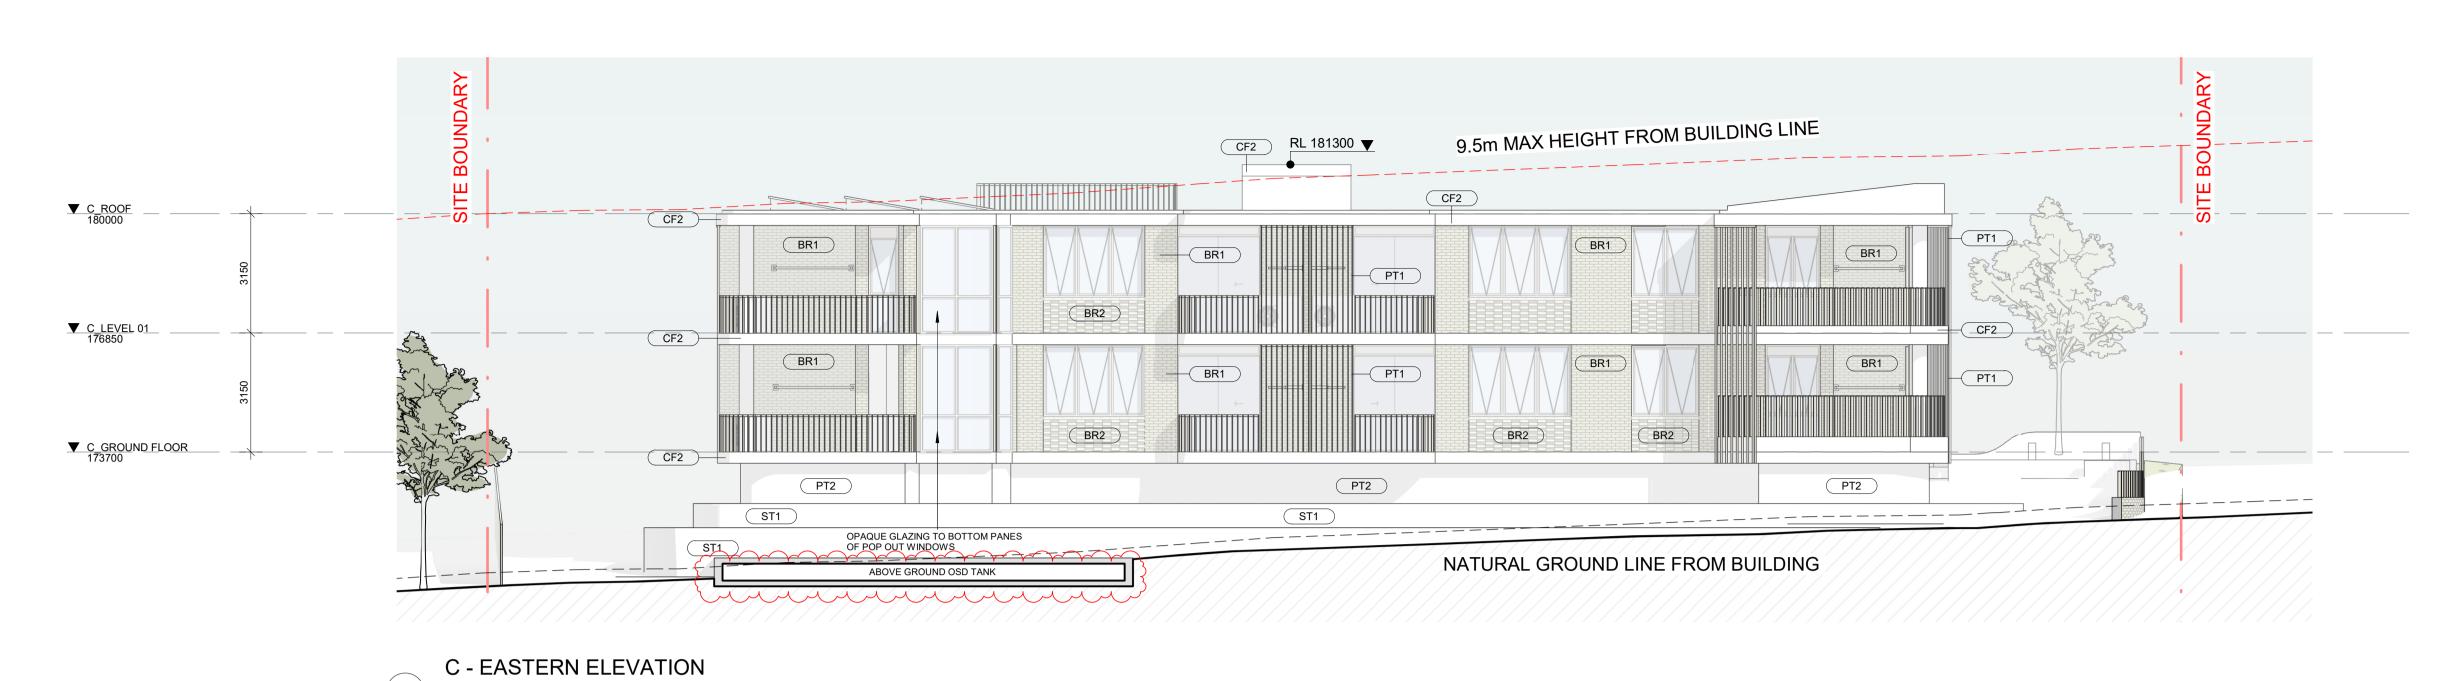


PROJECT: #2023103 1-17 BARRETT AVE **THORNLEIGH** 


DRAWING TITLE: **BUILDING ELEVATIONS** 

SHEET NUMBER: REV: **DA-3006** DATE: 30/07/2025





THE NATURAL GROUND LINE HAS BEEN MEASURED FROM THE BUILDING ELEVATION LINE. WHEN EXTRUDING THE HEIGHT PLANE TOWARDS THE WEST, THIS EXTENDS ABOVE THE LIFT OVER RUN. REFER TO THE 3D HEIGHT PLANE DIAGRAM FOR

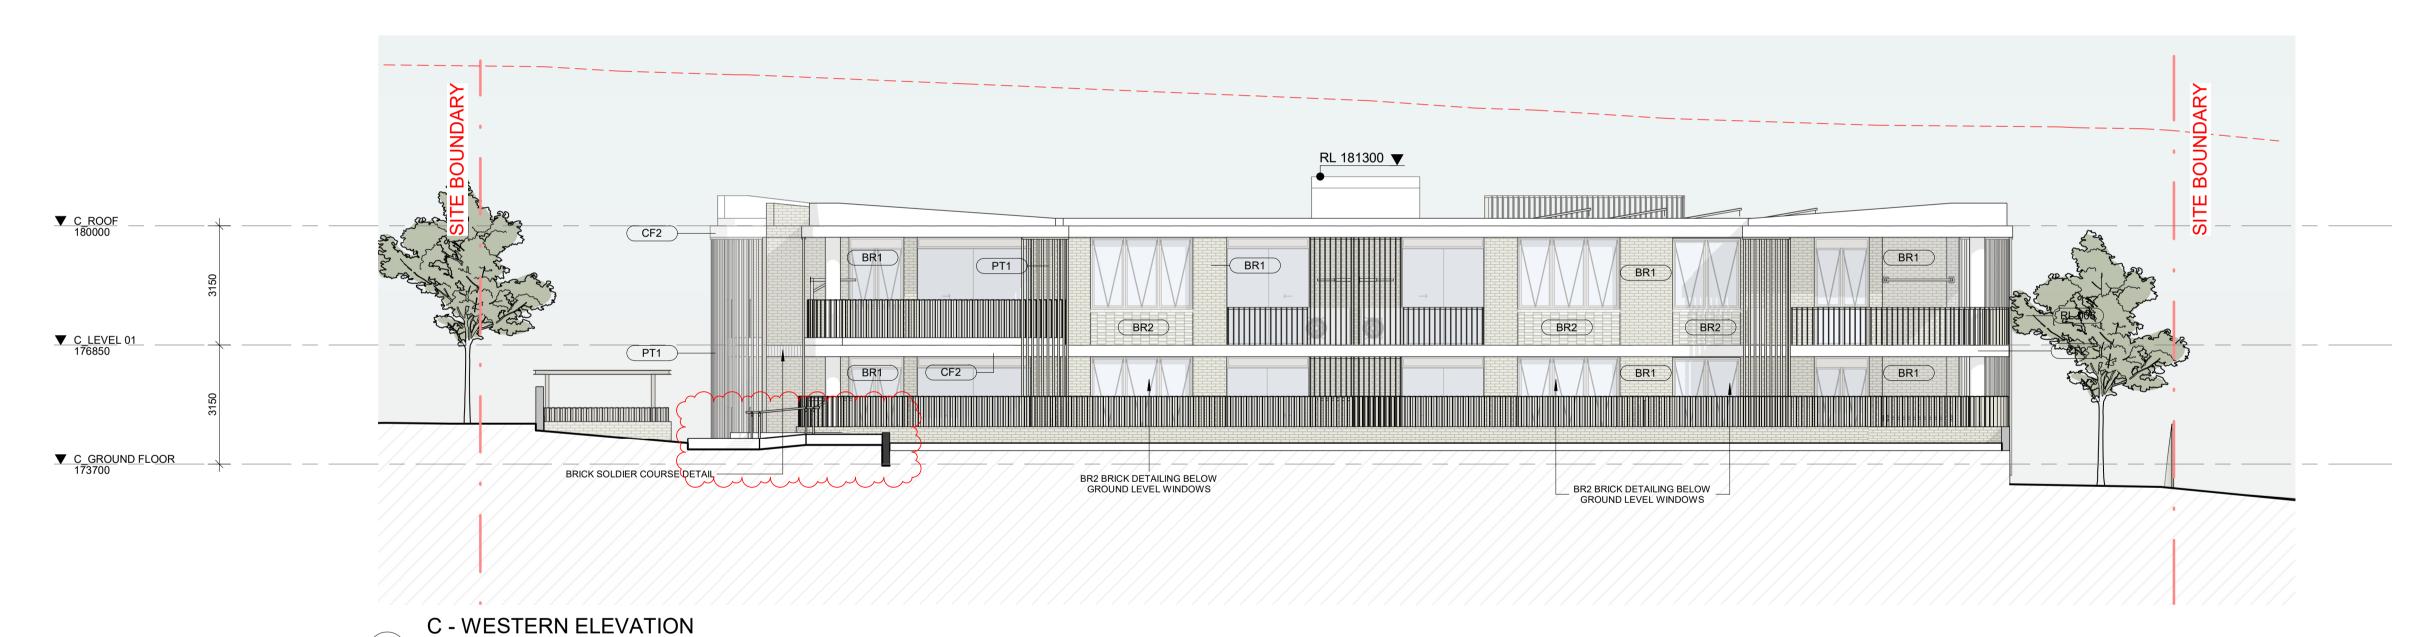



**CF1** - FIBRE CEMENT BARESTONE CEMINTEL

REV DATE DESCRIPTION

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P2 03/09/2024 FOR INFORMATION

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P6 30/07/2025 DA SUBMISSION



CF2 - C2 CONCRETE FINISH



**BR1** - BRICK FINISH BOTANICALS JUNIPER PGH BRICKS OR SIMILAR

DETAILING

**BR2** - STAGGERED BRICK



**PT1** - POWDERCOAT BRONZE (WINDOW FRAMES, BALUSTRADES & SCREENS)



PT2 - PAINT FINISH - GREY



**ST1** - RETAINING CONCRETE BLOCKS OR SIMILAR

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LEGEND:

MAXIMUM HEIGHT ALLOWED NATURAL GROUND LEVEL

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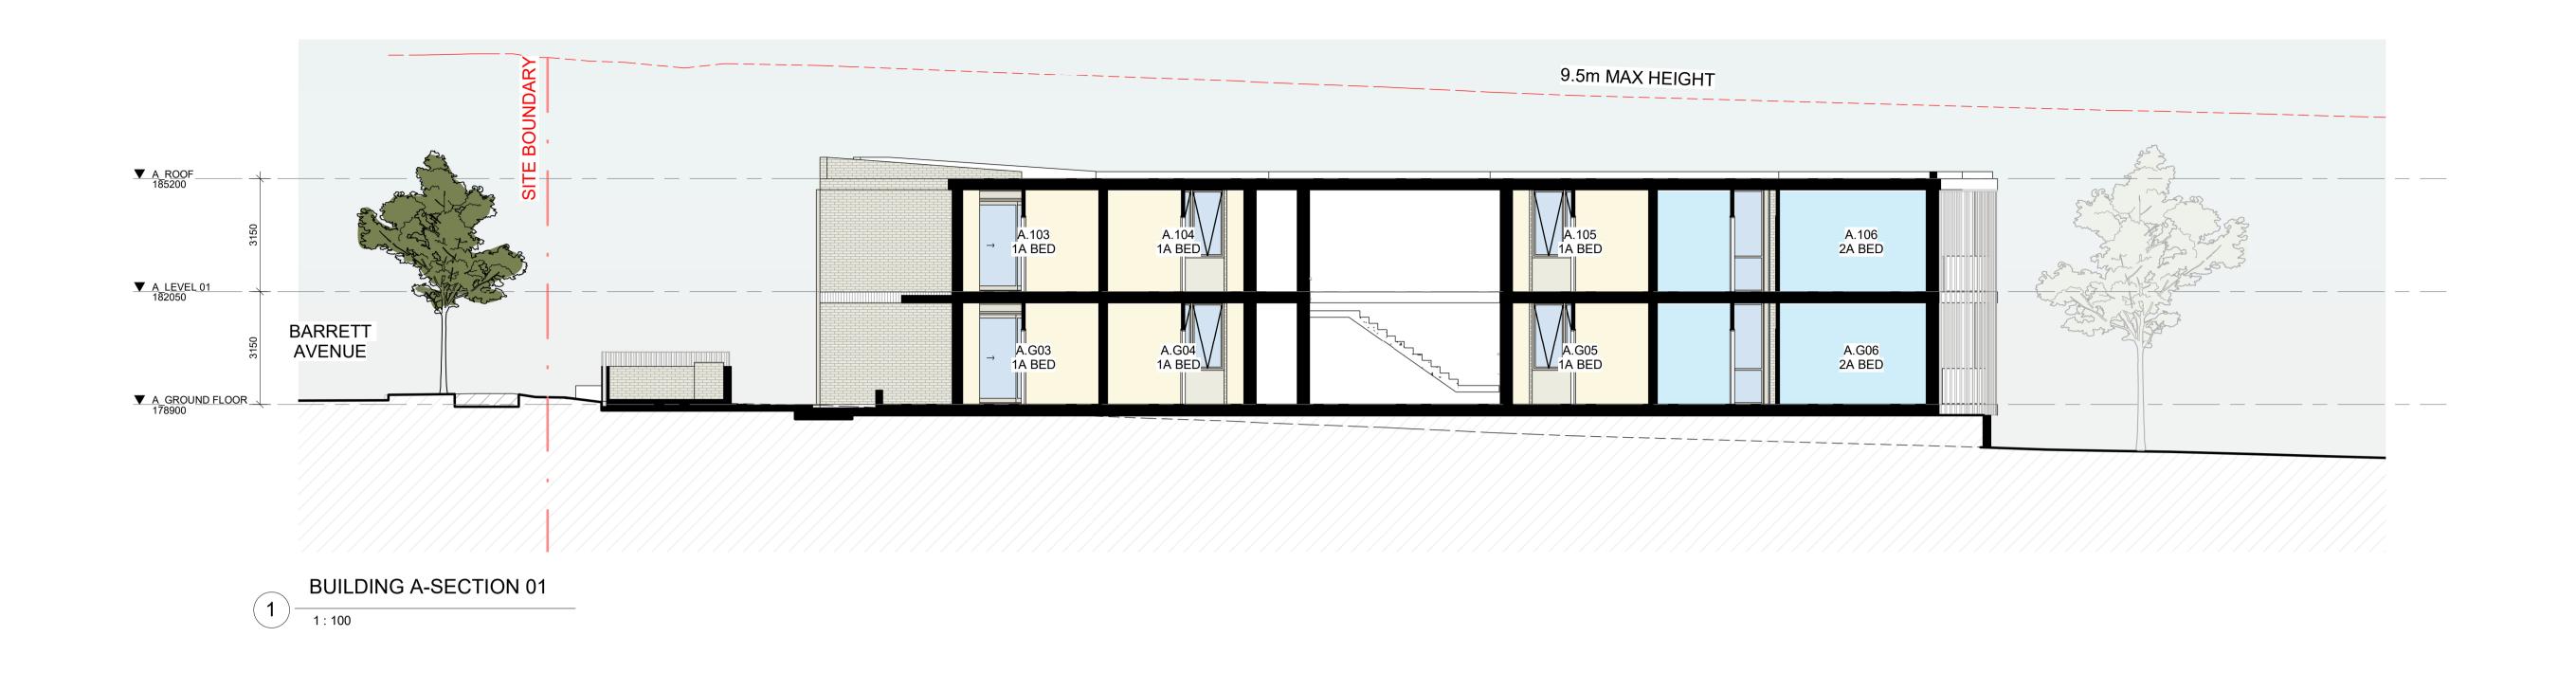
PROJECT: #2023103 1-17 BARRETT AVE **THORNLEIGH** 

DRAWING TITLE: **BUILDING ELEVATIONS** 

SHEET NUMBER: REV: **DA-3007** 

DATE: 30/07/2025

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LEGEND:

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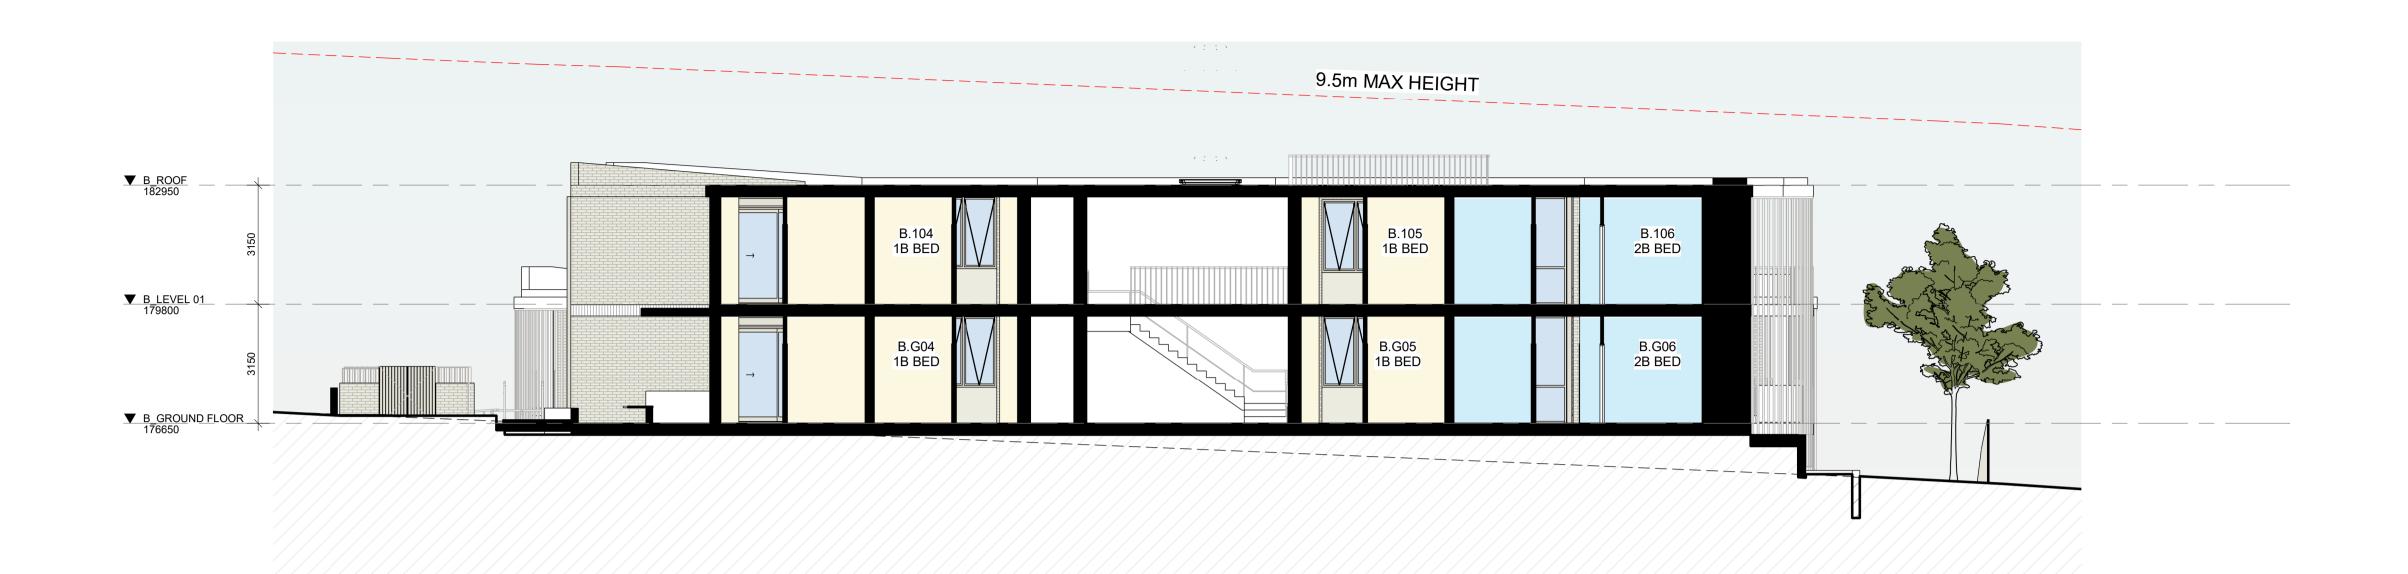
PROJECT: #2023103 1-17 BARRETT AVE THORNLEIGH

DRAWING TITLE: **BUILDING SECTIONS** 


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BUILDING B - SECTION 1



BUILDING B - SECTION 02

1:100

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precedence over drawings made to smaller scales or for general purposes. All work is to conform to relevant Australian Standards and Codes together with all Authorities' requirements and Regulations.
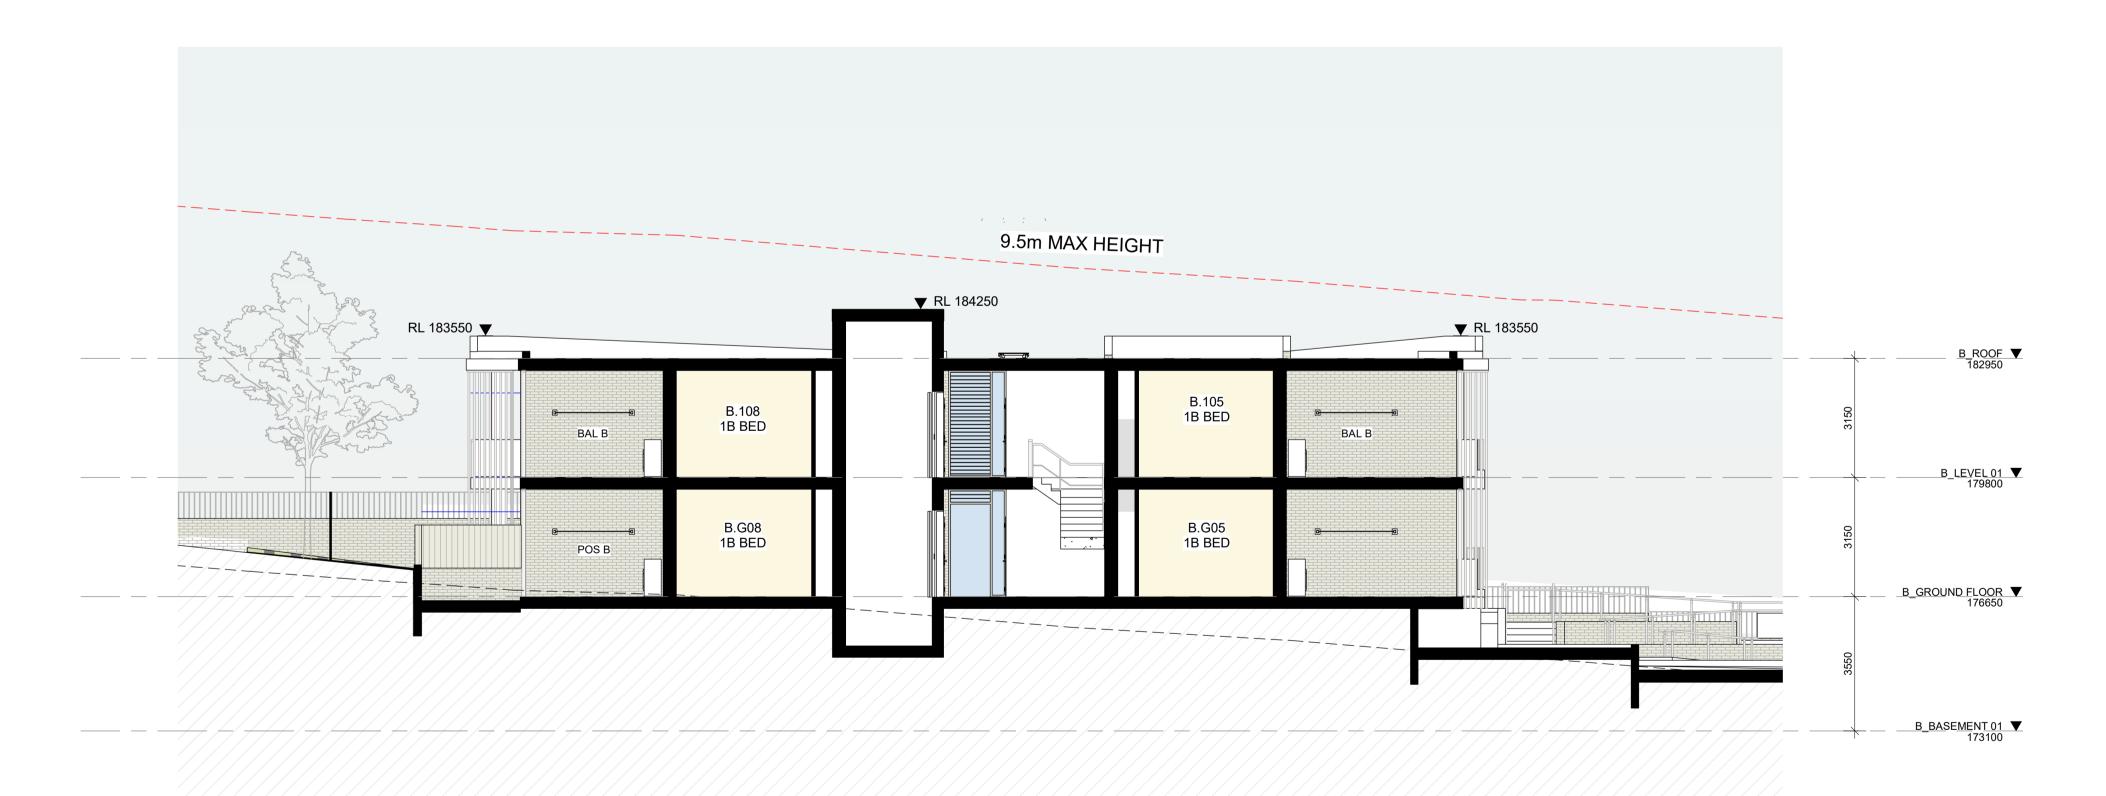
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LEGEND:

NATURAL GROUND LEVEL — — — —

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#2023103
1-17 BARRETT AVE
THORNLEIGH

DRAWING TITLE:
BUILDING SECTIONS

SHEET NUMBER:

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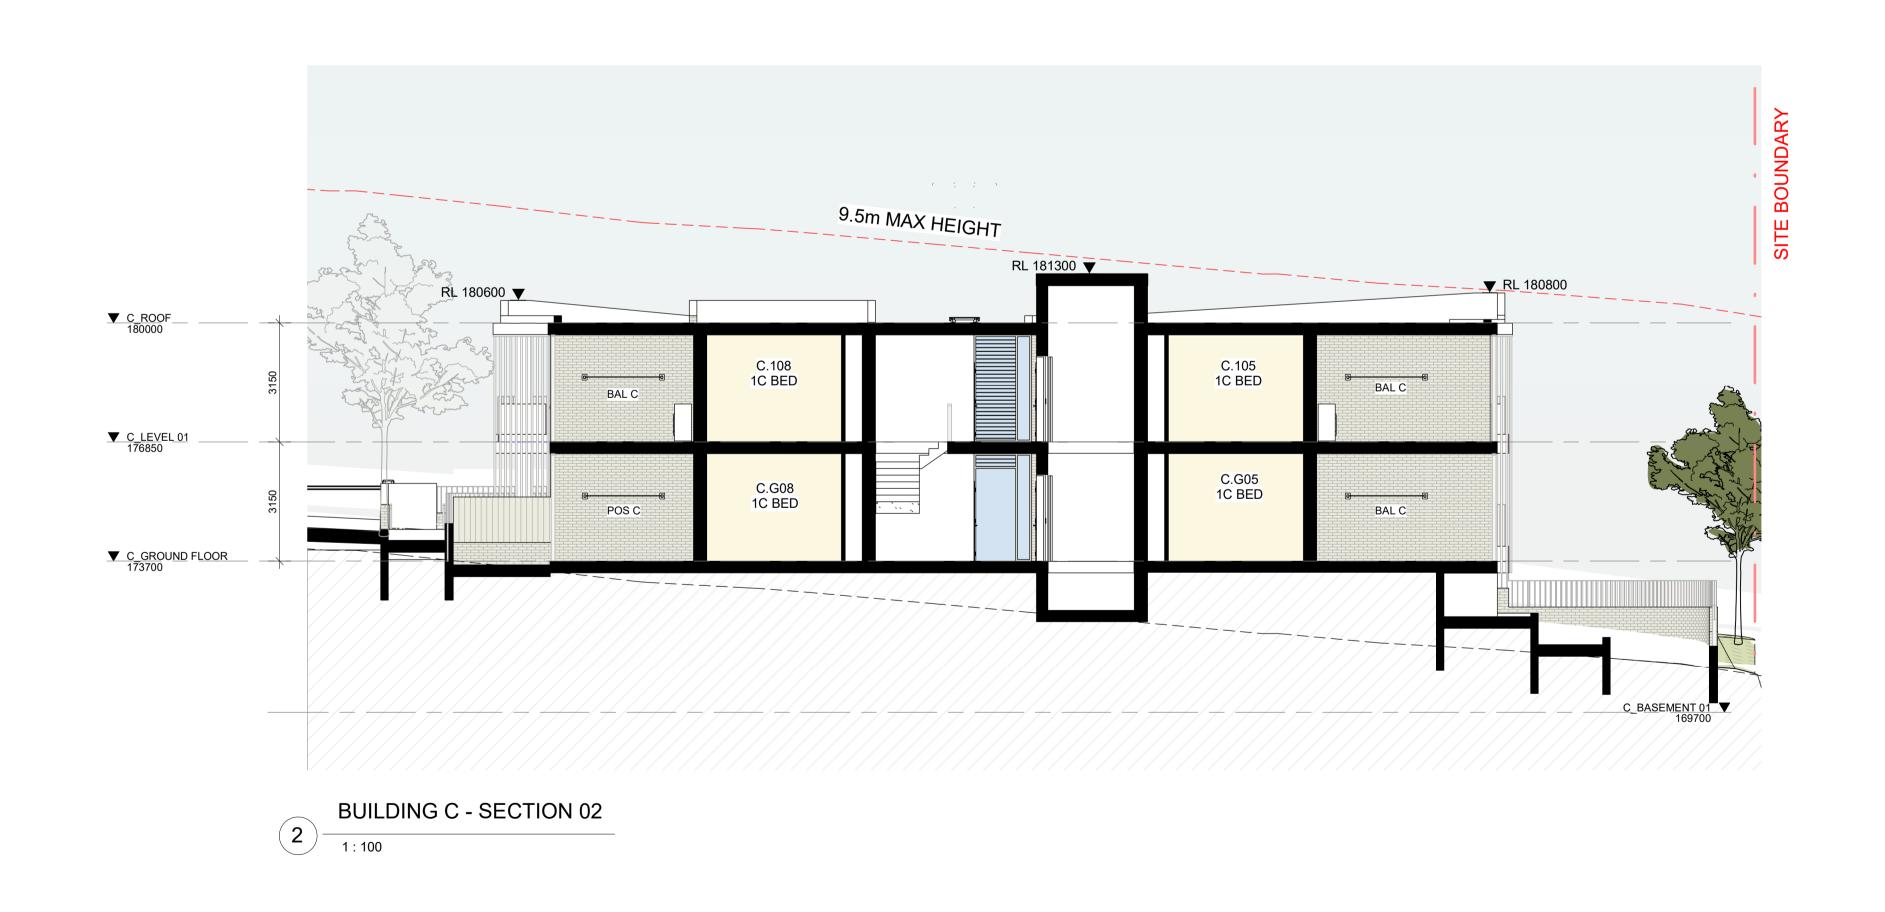
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BUILDING C - SECTION 1



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LEGEND:

NATURAL GROUND LEVEL — — — —

SCALE: 1:100@A1

PROJECT: #2023103 1-17 BARRETT AVE THORNLEIGH


DRAWING TITLE: **BUILDING SECTIONS** 

SHEET NUMBER: **DA-4002** 

DATE: 30/07/2025

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## LANDSCAPE PATH & FENCE DETAILS

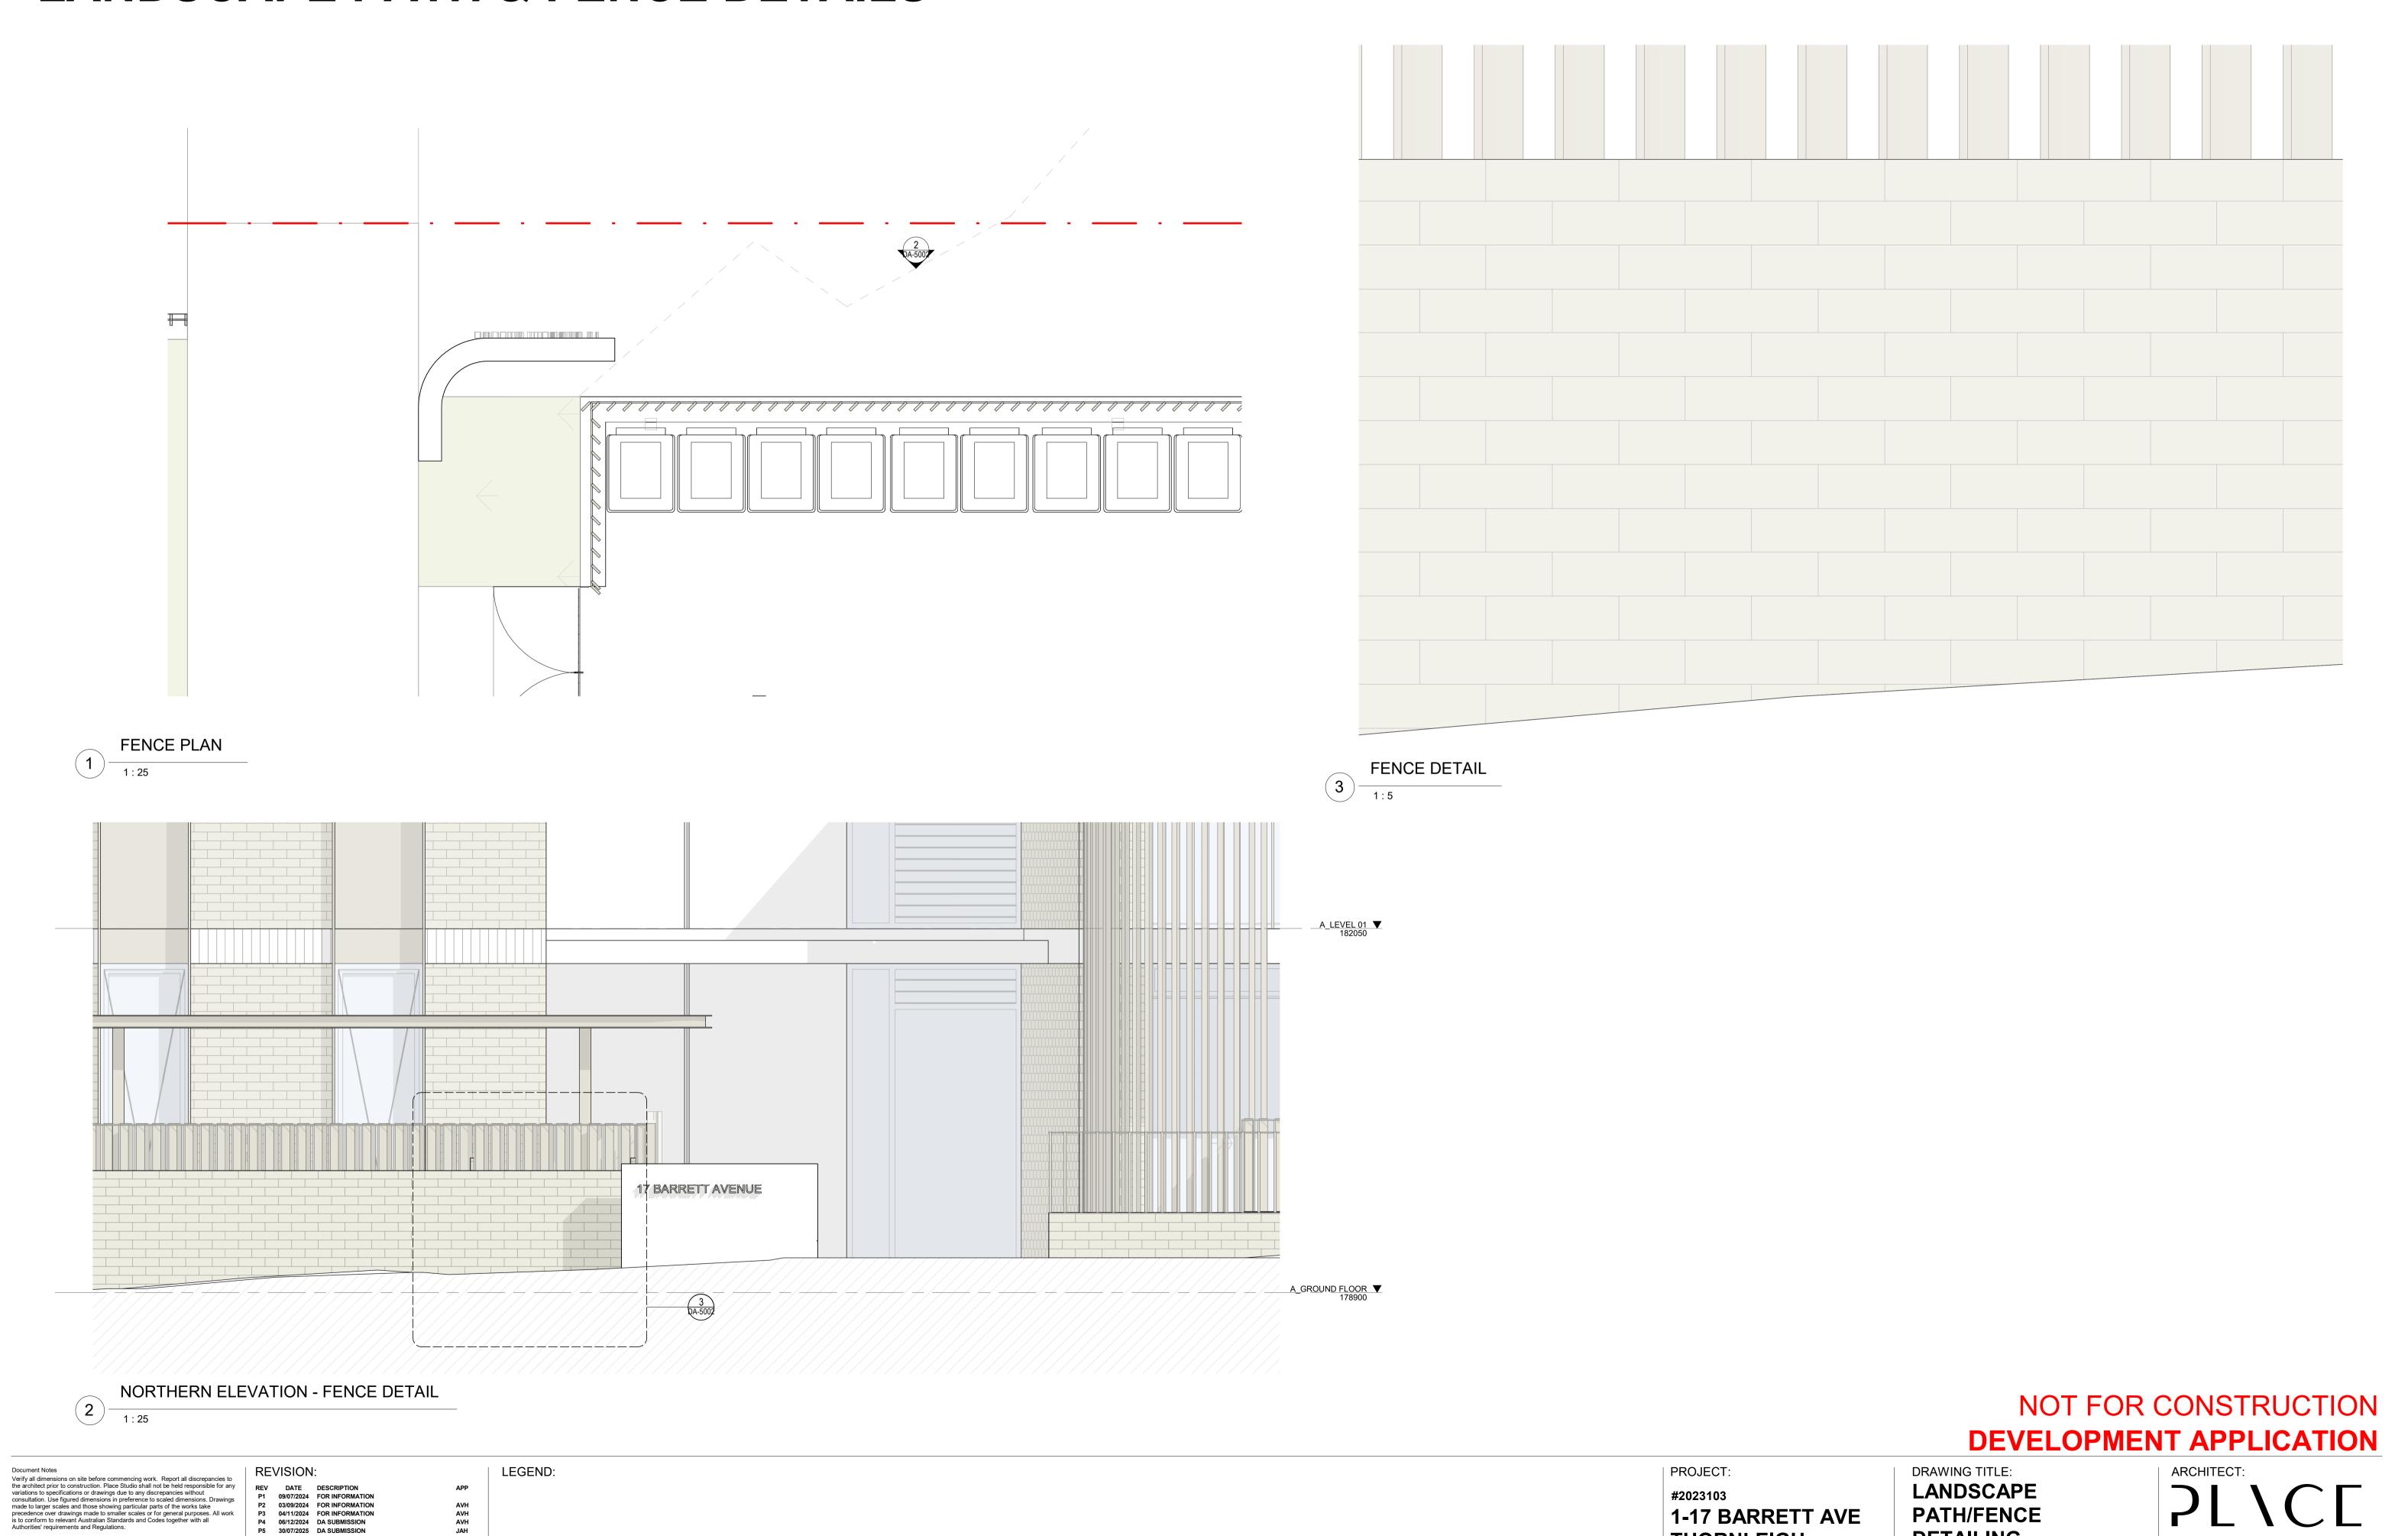

**DETAILING**SHEET NUMBER:

DA-5002

DATE: 30/07/2025

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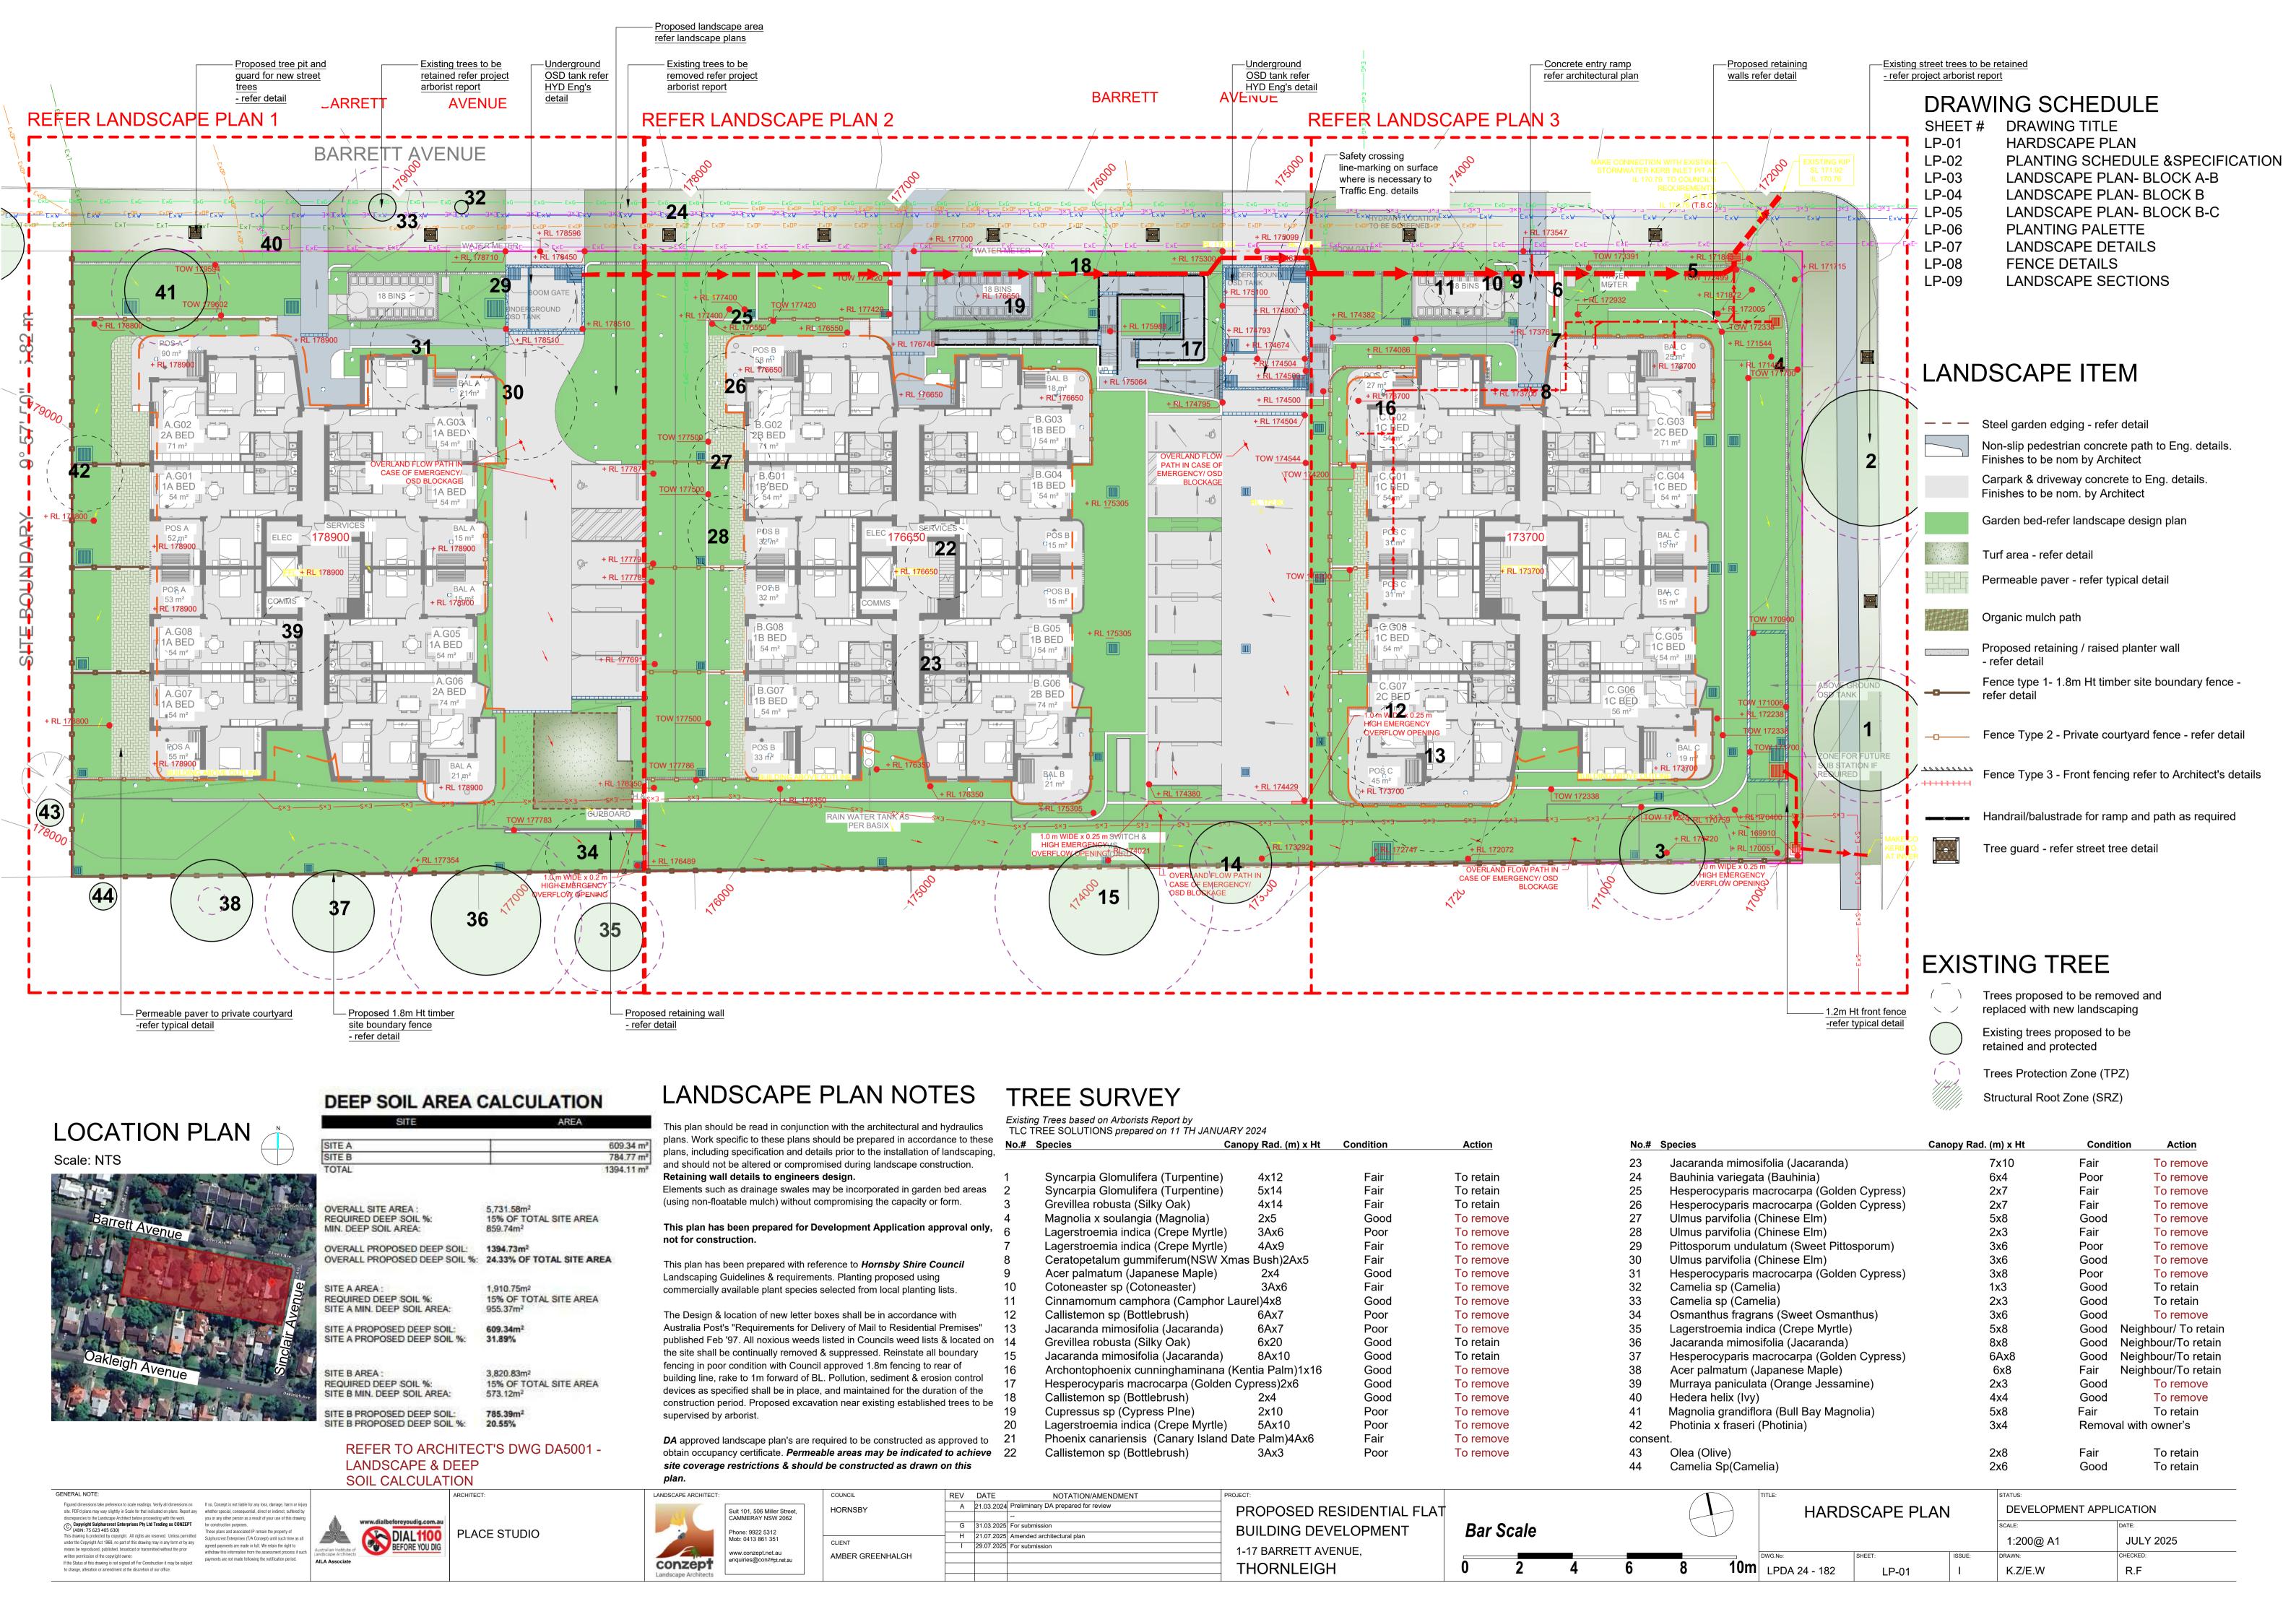
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#### \*DECIDUOUS ^EVERGREEN

#### FEATURE TREES (in 75Lt)

KEY	Botanical Name	Common Name	Qty
BS	^Banksia serrata (5-6mx3m)	Old Man Banksia (Native)	2
CG	*Ceratopetalum gummiferum (6-7mx4m)	NSW Christmas Bush	4
CSB	Corymbia Summer Beauty(5-6m x 4m)	Dwarf Flowering Gum(Native)	18
LN	*Lagerstroemia 'Natchez' (6x4m)	Crepe Myrtle (Exotic)	3

#### LARGE TREES (in 75Lt) **Botanical Name**

KEY	Botanical Name	Common Name	Qty
AC	^Angophora costata (15x13m)	Sydney Red Gum	2
AS	^Acmena Smithii (10x8m)	Turpentine (Native)	2
ВС	^Backhousia citriodora	Lemon scented Myrtle (Native)	2
ER	^Elaeocarpus reticulatus (6-8 x 3-5m)	Blueberry Ash (Native)	6
ML	^Melaleauca linariifolia(8x6m)	Snow in Summer (Native)	3
TLL	^Tristaniopsis laurina 'Luscious'(8-12x6m)	Watergum(Native)	10
WF	<b>^</b> Waterhousia floribunda(10x6m)	Weeping Lilly Pilly (Native)	5

#### SCREEN PLANTING (in 200mm)

KEY	Botanical Name	Common Name	Qty
ASM	^Acmena smithii 'Minor' (4m x 2m)	Lilly Pilly	66
SR	^Syzygium 'Resilience'(2.5x2.0m)	Lilly Pilly	35
SC	^Syzygium 'Cascade'(2.5x1.5m)	Lilly Pilly	96
CGBF	^Callistemon 'Great Balls of Fire'	GBoF Bottle Brush (Native)	45

#### SHRUBS (in 200mm)

KEY	Botanical Name	Common Name	Qty
CBJ	Callistemon 'Better John'(1x0.9m)	Better John Bottlebrush (Native)	107
LGS	^Leucodandron 'Gold strike' (1-1.5m x 1.5m)	Leucodandron (Exotic)	55
LC	^Loropetalum chinense 'Plum gorgeous' (1.5	m x 2m)Loropetalum (Exotic)	9
MT	^Melaleuca thymifolia(1.2m x 1-2m)	Thyme honey-myrtle (Native)	43
RI	^Rhaphiolepis indica' Oriental Pearl' (1x1m)	Indian Hawthorn (Exotic)	116
WFA	^Westringia 'Aussie Box'(0.8x1.0m)	Coastal Rosemary (Native)	184

#### **ACCENT PLANTING** (in 200mm)

KEY	Botanical Name (Mature HxS)	Common Name	Qty
AZ	^Alpinia zerumbet 'Variegata'(1.8x1m)	Variegated Shell Ginger (Exotic)	90
DE	*Doryanthes excelsa (1x1m)	Gymea Lily	29
RE	^Rhaphis excelsa (1-3m x 1m)	Rhaphis Palm (Exotic)	42
PTP	^Phormium tenax 'Purpureum'(0.9mx0.9m)	New Zealand Flax (Exotic)	32
PX	^Philodendron 'Xanadu' (0.8mx0.7m)	Philodendron'Xanadu' (Exotic)	123
SN	Strelitzia nicolai (3-6m x 3m)	Giant Bird of Paradise (Exotic)	

### CARPET GROUNDCOVER (in 140mm)

BM	<b>^</b> Brachycome multifida(0.4x0.6m)	Swan River Daisy (Native)	440@5/m2 (88m2 total) for construction techniques
CAR	*Carpobrotus 'Aussie Rambler'(0.2m)A	ussie Rambler Pigface (Native)	435@5/m2 (87m2 total) <sub>SOIL</sub> WORKS
CRM	^Grevillea 'Royal Mantle'(0.3mx s)	Royal Mantle Grevillea (Native)	500@5/m2 (100m2 total)2.01 MATERIALS
DR	^Dichondra repens(0.15mxs)	Kidney Weed (Native)	574@7/m2 (82m2 total) Specified Soil Conditioner (Generally to improve site soil)
MPY	^Myoporum parvifolium 'Yareena'	Creeping Boobialla	The specified soil conditioner for site top-soil improvement shall be an arganic mix, equal to "Botany Humus", as supplied by ANL. Note that for
PP	^Pratia pedunculata	White Star Creeper	410@5/m2 (83m2 total) sites where soil testing indicates toxins or extremes in pH, or soils that are extremely poor, allow to excavate and supply 300mm of imported soil mix.
	ACE O CDACC		• • • • • • • • • • • • • • • • • • • •

#### FOLIAGE & GRASS (in 140mm)

**Botanical Name** 

KEY	Botanical Name	Common Name	Qty
LL	Lomandra longifollia 'Tanika'*	Mat Rush	365 @ 5/m2 (73m2 total)
DT	Dianella tasmanica 'Tasred*	Tasred Blue Flax	1100@5/m2 (220m2 total)
LM	Libertia paniculata*	Grass Flag	500@5/m2 (100m2 total)

#### NATIVE FERNS MIXES (in 140mm)

Area:140m<sup>2</sup> (Refer to LP-07 for Matrix Detail)

KEY	Botanical Name	Common Name	Ratio / Qty
ADI	Adiantum spp (0.3m x 0.5m)	Maidenhair Fern	3 per m² /420
BC	Blechnum cartilagineum	Gristle Ferns	1 per m²/140
DA	Doodia aspera	Prickly Rasp Fern	1 per m²/140
CD	Christella dentata	Binung	1 per m²/140

#### LANDSCAPE WORK SPECIFICATION

#### **PRELIMINARIES**

#### 1.01 GENERAL

The following general conditions should be considered prior to the commencement of landscape works:

- The landscape plans should be read in conjunction with the architectural plans, project arborist's assessment, hydraulic plans, service plans and survey prepared for the proposed development.
- All services including existing drainage should be accurately located prior to the commencement of landscape installation. Any proposed tree planting which falls close to services will be relocated on site under the instruction of the landscape architect.
- Installation of conduit for required irrigation, electrical and other services shall be completed prior to the commencement of hardscape works and hardstand pours.
- All outdoor lighting specified by architect or client to be installed by qualified electrician
- Anomalies that occur in these plans should be brought to our immediate attention.
- Where an Australian Standard applies for any landscape material testing or installation technique, that standard shall be followed.

#### 1.02 PROTECTION OF ADJACENT FINISHES

The Contractor shall take all precautions to prevent damage to all or any adjacent finishes by providing adequate protection to these areas / surfaces prior to the commencement of the Works

#### 1.03 PROTECTION OF EXISTING TREES

Existing trees identified to be retained shall be done in accordance with (AS)4970-Protection of trees on development sites as well as in accordance with the tree protection measures prepared by project arborist.

Where general works are occurring around such trees, or pruning is required, a qualified Arborist shall be engaged to oversee such works and manage tree health.

Existing trees designated on the drawing for retention shall be protected at all times during the construction period. Any soil within the drip-line of existing trees shall be excavated and removed by hand only. No stockpiling shall occur within the root zone of existing trees to be retained.

Any roots larger in diameter than 50mm shall only be severed under instruction by a qualified arborist. Roots smaller than 50mm diameter shall be cut cleanly with a saw.

Temporary fencing shall be installed around the base of all trees to be retained prior to the commencement of landscape works. Where possible this fencing will be located around the drip line of these trees, or a minimum of 3m from the trunk. The fencing shall be maintained for the full construction

#### 1.04 EROSION & POLLUTION CONTROL

The Contractor shall take all proper precautions to prevent the erosion of soil from the subject site. The contractor shall install erosion & sediment control barriers and as required by council, and maintain these barriers throughout the construction period. Note that the sediment control measures adopted should reflect the soil type and erosion characteristics of the site.

Erosion & pollution control measures shall incorporate the following: Construction of a sediment trap at the vehicle access point to the subject site.

Sediment fencing using a geotextile filter fabric in the location indicated on the erosion control plan or as instructed on site by the

- Earth banks to prevent scour of stockpiles
- Sandbag kerb sediment traps
- Straw bale & geotextile sediment filter. Exposed banks shall be pegged with an approved Jute matting in preparation for mass planting

Refer to "Sitewise Reference Kit" as prepared by DLWC & WSROC (1997) for construction techniques

#### .01 MATERIALS

#### **New gardens & proposed Planting**

New garden and planting areas shall consist of a 50/50 mix of clean site soil (refer d) below) and imported "Organic Garden Mix" as supplied by ANL or approved equal. All mixes are to comply with AS 4419 Soils for landscaping & garden use, & AS 4454 Composts, Soil conditioners & mulches.

#### **Specified Soil Mix - Turf**

The specified soil mix for all turf areas shall be a min 75mm layer of imported soil mix consisting of 80% washed river sand (reasonably coarse), and 20% composted organic matter equivalent to mushroom compost or soil

PALM & LARGE FERN (45Lt MIN 1m TRUNK)

#### conditioner, or other approved lawn top dress.

Site topsoil is to be clean and free of unwanted matter such as gravel, clay lumps, grass, weeds, tree roots, sticks, rubbish and plastics, and any deleterious materials and materials toxic to plants. The topsoil must have a pH of between 5.5 and 7. Use 100% imported soil mix when site when site topsoil runs out.

#### 2.02 INSTALLATION (TO GARDEN OUTSIDE OF TREE PROTECTION **ZONES OF TREES RECOMMENDED TO BY RETAINED)** Note: No level changes (Cut or Fill), soil ripping within the Tree

Protection Zones of trees to be retained

#### a) Testing

All testing is to be conducted in accordance with AS 1289 Methods for testing soils for engineering purposes. Site soil shall be given a pH test prior to modifying to ensure conditions are appropriate for planting as stated above. Tests shall be taken in several areas where planting is proposed, and the pH shall be adjusted accordingly with sulphur or lime to suit.

Note that a soil test conducted by the "Sydney Soil Lab" or approved equal shall be prepared for all commercial, industrial and multi-unit residential sites. The successful landscape contractor shall implement the recommendations of this test.

#### b) Set Out of Individual Trees & Mass Planting Areas

All individual tree planting positions and areas designated for mass planting shall be set out with stakes or another form of marking, ready for inspection and approval. Locate all services.

#### c) Establishing Subgrade Levels outside of tree protection zones of trees to be retained

Subgrade levels are defined as the finished base levels prior to the placement of the specified material (i.e. soil conditioner). The following subgrade levels shall apply:

- Mass Planting Beds 300mm below existing levels with specified imported soil mix.
- Turf areas 100mm below finished surface level. Note that all subgrades shall consist of a relatively free draining natural material, consisting of site topsoil placed previously by the Civil Contractor. No builders waste material shall be acceptable.

#### d) Subgrade Cultivation

Cultivate all subgrades to a minimum depth of 100mm in all planting beds and all turf areas, ensuring a thorough breakup of the subgrade into a reasonably coarse tilth. Grade subgrades to provide falls to surface and subsurface drains, prior to the placement of the final specified soil mix.

#### e) Drainage Works

Install surface and subsurface drainage where required and as detailed on the drawing. Drain subsurface drains to outlets provided, with a minimum fall of 1:100 to outlets and / or service pits.

#### Placement and Preparation of Specified Soil Conditioner & Mixes.

- Trees in turf & beds Holes shall be twice as wide as root ball and minimum 100mm deeper - backfill hole with 50/50 mix of clean site soil and imported "Organic Garden Mix" as supplied by ANL or approved
- Mass Planting Beds Install specified soil conditioner to a compacted

Place the specified soil conditioner to the required compacted depth and use a rotary hoe to thoroughly mix the conditioner into the top 300mm of garden bed soil. Ensure thorough mixing and the preparation of a reasonably fine tilth and good growing medium in preparation for planting.

• Turf Areas - Install specified soil mix to a minimum compacted depth of

Place the specified soil mix to the required compacted depth and grade to required finished soil levels, in preparation for planting and turfing.

#### **PLANTING**

#### 3.01 MATERIALS

#### a) Quality and Size of Plant Material

All trees supplied above a 25L container size must be grown and planted in accordance with AS 2303:2018 'TREE STOCK FOR LANDSCAPE USE' Certification that trees have been grown to AS 2303:2018 is to be provided upon request of Council's Tree Management Officer.

#### Above - Ground Assessment:

The following plant quality assessment criteria should be followed: Plant true to type, Good vigour and health, free from pest & disease, free from injury, self-supporting, good stem taper, has been pruned correctly, is apically dominant, has even crown symmetry, free from included bark & stem junctions, even trunk position in pot, good stem structure Below - Ground Assessment:

Good root division & direction, rootball occupancy, rootball depth, height of crown, non-suckering For further explanation and description of these assessment criteria, refer to Ross Clark's book.

All Plant material shall be to the type and size specified. No substitutions of plant material shall be permitted without written prior approval by the Landscape Architect. No plant shall be accepted which does not conform to the standards listed above.

#### b) Stakes and Ties

NOTATION/AMENDMENT

Provide min. 3 No. Stakes and ties to all plants identified as trees in the plant schedule. Stakes shall be sound, unpainted, straight hardwood, free of knots and pointed at one end. They shall be 1800mm x 50mm x 50mm Hardwood timber, or as per council specification where is available. Ties shall be

#### 50mm wide hessian webbing material.

#### c) Fertilisers

Fertilisers shall be approved slow release fertilisers suitable for the proposed planting types. Note that for native plants, specifically Proteaceae family plants including Grevillea species, low phosphorus fertilizers shall be used.

Mulch for general planter bed shall be an approved equal to "Eucy Mulch or approved equivalent naturally sources organic mulch" as supplied by ANL. Mulch shall be completely free from any soil, weeds, rubbish or other debris. Mulch for bio-retention/rain garden area where is required shall be non-floatable materials that could include crushed rock, gravel, coarse river sand, scoria or river pebbles. 4-7mm screenings or similar.

#### e) Turf

Turf for project site shall be soft leaf Buffalo or Zoysia macrantha 'Nana' or equivalent unless stated otherwise), free from any weeds and other grasses, and be in a healthy growing condition. Re-turfing to nature strip where is required shall use species that match existing on street.

#### 3.02 INSTALLATION

#### a) Setting Out

All planting set out shall be in strict accordance with the drawings, or as directed. Note that proposed tree planting located near services should be adjusted at this stage. Notify Landscape Architect for inspection for approval prior to planting.

b) Planting All plant material shall be planted as soon after delivery as possible. Planting holes for trees shall be excavated as detailed and specified. Plant containers shall be removed and discarded, and the outer roots gently teased from the soil mass. Immediately set plant in hole and backfill with specified soil mix, incorporating the approved quantity of fertiliser for each plant type. Ensure that plants are set plumb vertically and root balls set to the consolidated finished grades detailed on the drawings. Compact the backfilled soil and saturate by hand watering to expel any remaining air pockets immediately after planting.

#### c) Staking and Tying

Staking and tying shall be in strict accordance with the drawings and shall occur immediately following plant placement and soil backfilling. All plants identified as "Trees" on the planting schedule shall be staked with a min. 3 stakes.

#### d) Mulching

No combustible mulch should be used onsite. Mulch should be spread so that a compacted thickness of 75mm is achieved after settlement in all planting beds and around each individual plant. Apply immediately following planting and watering in, ensuring that a 50mm radius is maintained around the trunk of each plant. There shall be no mixing of soil and mulch material.

#### e) Turfing

Moisten soil prior to the turf being laid. Turf shall be neatly butt jointed and true to grade to finish flush with adjacent surfaces. Incorporate a lawn fertilizer and thoroughly water in. Keep turf moist until roots have taken and sods/rolls cannot be lifted. Keep all traffic off turf until this has occurred. Allow for top dressing of all turf areas. All turf shall be rolled immediately following installation.

#### f) Metal edging

Where is required, the Contractor shall install metal edging as detailed on the drawings, to all mass planting beds adjoining turf or gravel mulched areas, and where required. The resultant edge shall be true to line and flush with adjacent surfaces. However, no edging shall be used within the Structural Root Zone (SRZ) of trees to be retained.

#### g) Earth retaining structure

All walls which form part of drainage works must be built as detailed by the hydraulic engineer. All walls exceeding 800mm shall be of **not** timber construction materials, construction details to be provided by a qualified engineer. Install wall to suit site levels and to manufacture's specification.

#### HARDSCAPE WORKS

#### 4.01 GENERAL

The Contractor shall undertake the installation of all hardscape works as detailed on the drawing, or where not detailed, by manufacturers specification

 Paving - refer to typical details provided, and applicable Australian Standards. Permeable paving may be used as a suitable means of satisfying Council permeable surface requirements, while providing a useable, hardwearing, practical surface. In most instances, the client shall nominate the appropriate paving material to be used.

Australian Standards shall be adhered to in relation to all concrete, masonry & metal work. Some details are typical and may vary on site. All hardscape works shall be setout as per the drawings, and inspected and approved by the Landscape Architect prior to installation. All workmanship shall be of the highest standard. Any queries or problems that arise from hardscape variations should be bought to the attention of the Landscape Architect. Your attention is directed to any obligations or responsibilities under the Dividing Fences Act, 1991 in respect of adjoining property owner/s which may arise from this application. Any enquiries in this regard may be made to the Crown Lands Division on (02) 8836 5332.

#### **IRRIGATION WORKS**

New irrigation systems to planting areas shall be a Commercial Grade Irrigation System conforming to all relevant Australian standards, including statutory requirments for backflow prevention, AS/NZS 3500:1, Workplace Health & Safety Act 2011, & the latest Sydney Water Code

An automated drip-irrigation system is to be installed to all gardens, planters and lawn areas in accordance with the approved Irrigation Design. This system shall be designed and installed by a qualified irrigation specialist, to industry standards and to maximise the efficient usage of water in accordance with council's requirement on minimum average water usage

The Landscape Contractor nominated Licensed Irrigation Specialist shall provide irrigation drawings for approval upon engagement.

A full 12 month warranty shall be included to cover labour and all

#### Refer to separate Irrigation Performance Specification.

**CONSOLIDATION AND MAINTENANCE** 

#### 6.01 GENERAL

The consolidation and maintenance period shall be either:

- 12 months beginning from the approved completion of the specified construction work (Practical Completion)
- as agreed to in the landscape contractors contractual obligations.

 or as specified by Council in the Determination. A qualified landscape maintenance contractor shall undertake the required landscape maintenance works. Consolidation and maintenance shall mean the care and maintenance of Contracted works by accepted landscaping or horticultural practices, ensuring that all plants are in optimum growing conditions and appearance at all times, as well as rectifying any defects that become apparent in the contracted works.

This shall include, but not be limited to, the following items where and as

- Watering all planting and lawn areas / irrigation maintenance.
- Clearing litter and other debris from landscaped areas. Removing weeds, pruning and general plant maintenance.
- Replacement of damaged, stolen or unhealthy plants.
- Make good areas of soil subsidence or erosion.
- Topping up of mulched areas.
- Spray / treatment for Insect and disease control. Fertilizing with approved fertilizers at correct rates.
- Mowing lawns & trimming edges each 14 days in summer or 18 days in
- Adjusting ties to Stakes
- Maintenance of all paving, retaining and hardscape elements.

On the completion of the maintenance period, the landscape works shall be inspected and at the satisfaction of the superintendent or landscape architect, the responsibility will be signed over to the client.

#### Refer to Landscape Maintenance strategy

#### DEVELOPMENT APPLICATION PLANT SCHEDULE & **SPECIFICATION** AS SHOWN @ A1 **JULY 2025** K.Z/E.W R.F LPDA 24 - 182 LP-02

## GENERAL NOTE:













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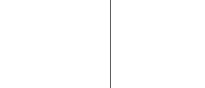
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LANDSCAPE ARCHITECT

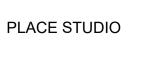
**Botanical Name** 

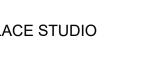
Howea forsteriana

**^**Cvathea australis

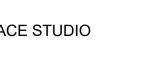

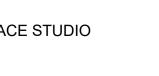

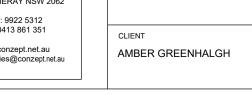

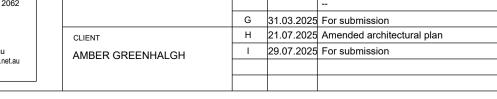

*Kentia P*alm

Rough Tree Fern

Qty


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A 21.03.2024 Preliminary DA prepared for review

PROPOSED RESIDENTIAL FLAT **BUILDING DEVELOPMENT** 1-17 BARRETT AVENUE, **THORNLEIGH** 

#### **^EVERGREEN** \*DECIDUOUS

#### **REFER TO LP-02 FOR TOTAL PLANT QUANTITIES** FEATURE TREES (in 75Lt)

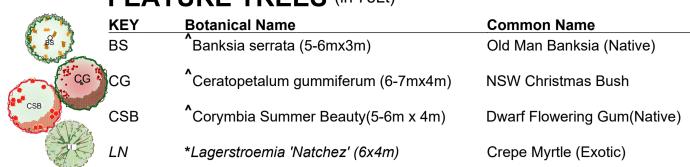

#### LARGE TREES (in 75Lt)

	( ro_t)			
m	KEY	Botanical Name	Common Name	
ASA	AC	^Angophora costata (15x13m)	Sydney Red Gum	
ER THE THE	AS	^Acmena Smithii (10x8m)	Turpentine (Native)	
A Com	BC	^Backhousia citriodora	Lemon scented Myrtle (Native)	
Market Market	ER	^Elaeocarpus reticulatus (6-8 x 3-5m)	Blueberry Ash (Native)	
1 22	ML	^Melaleauca linariifolia(8x6m)	Snow in Summer (Native)	
	TLL	^Tristaniopsis laurina 'Luscious'(8-12x6m)	Watergum(Native)	
	WF	^Waterhousia floribunda(10x6m)	Weeping Lilly Pilly (Native)	

#### SCREEN PLANTING (in 200mm)

KEY	Botanical Name	Common Name
ASM	^Acmena smithii 'Minor' (4m x 2m)	Lilly Pilly
SC	Syzygium 'Cascade'(2.5x1.5m)	Lilly Pilly (Native)
SR	^Syzygium 'Resilience' (3.0x2.0m)	Resilience Lilly Pilly (Native)
CGBF	*Callistemon 'Great Balls of Fire'	GBoF Bottle Brush (Native)

#### SHRUBS (in 200mm)

011110		
KEY	Botanical Name	Common Name
СВЈ	^Callistemon 'Better John' (1x0.9m)	Better John Bottlebrush (Native
LGS	^Leucodandron 'Gold strike' (1-1.5m x 1.5m)	Leucodandron (Exotic)
LC	^Loropetalum chinense 'Plum gorgeous' (1.5r	m x 2m)Loropetalum (Exotic)
MT	^Melaleuca thymifolia(1.2m x 1-2m)	Thyme honey-myrtle (Native)
RI	^Rhaphiolepis indica' Oriental Pearl' (1x1m)	Indian Hawthorn (Exotic)
WFA	^Westringia 'Aussie Box'(0.8x1.0m)	Coastal Rosemary (Native)

### ACCENT DI ANTINO

3	ACCENT PLANTING (in 200mm)			
B	KEY	Botanical Name (/	Mature HxS)	Common Name
	AZ	^Alpinia zerumbet 'Variegata'(	(1.8x1m)	Variegated Shell Ginger (Exotic)
	CA	^Cyathea australis (3	3x2m)	Rough Tree Fern
	DE	*Doryanthes excelsa (1x1m)		Gymea Lily
P	RE	^Rhaphis excelsa (?	1-3m x 1m)	Rhaphis Palm (Exotic)
	PTP	^Phormium tenax 'Purpureum	'(0.9mx0.9m)	New Zealand Flax (Exotic)
	PX SN	^Philodendron 'Xanadu' (0.8m	nx0.7m)	Philodendron'Xanadu' (Exotic)
	SN	Strelitzia nicolai (3-6m x 3m)		Giant Bird of Paradise (Exotic)

#### CARPET GROUNDCOVER (in 140mm)

CARPET GROUNDCOVER (In 140mm)		
KEY	Botanical Name	Common Name
ВМ	*Brachycome multifida(0.4x0.6m)	Swan River Daisy (Native)
CAR	^Carpobrotus 'Aussie Rambler'(0.2m x s)	Aussie Rambler Pigface (Native)
CRM	^Grevillea 'Royal Mantle'(0.3m x s)	Royal Mantle Grevillea (Native)
VH	^Viola hederacea(0.15m x s)	Native Violet (Native)
MPY	^Myoporum parvifolium 'Yareena'	Creeping Boobialla

#### FOLLAGE & ODAGO

^Pratia pedunculata

FOLIAGE & GRASS (in 140mm)			
KEY	Botanical Name	Common Name	
LL	Lomandra longifollia 'Tanika'*	Mat Rush	
DT	Dianella tasmanica 'Tasred*	Tasred Blue Flax	
LM	Libertia paniculata*	Grass Flag	
NATIVE FERNS MIXES (in 140mm)			

### 

0000	KEY	Botanical Name	Common Name
<b>:</b>	ADI	Adiantum spp (0.3m x 0.5m)	Maidenhair Fern
	ВС	Blechnum cartilagineum	Gristle Ferns
	DA	Doodia aspera	Prickly Rasp Fern

### PALM (45Lt MIN 1m TRUNK)

KEY	Botanical Name	Common Name	
		<u> </u>	
Arc	Howea forsteriana	<i>Kentia P</i> alm	

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PLACE STUDIO

White Star Creeper

conzept

LANDSCAPE ARCHITECT Suit 101, 506 Miller Street, Phone: 9922 5312 www.conzept.net.au enquiries@conzept.net.au

NOTATION/AMENDMENT A 21.03.2024 Preliminary DA prepared for review HORNSBY G 31.03.2025 For submission H 21.07.2025 Amended architectural plan I 29.07.2025 For submission AMBER GREENHALGH

PROPOSED RESIDENTIAL FLAT **BUILDING DEVELOPMENT** 1-17 BARRETT AVENUE, **THORNLEIGH** 

Bar Scale

3 CBJ 3 5

3 ASM

3 SR

18 BINS

 $13m^2 DR$ 

CASE OF EMERGENCY/

OSD BLOCKAGE

– 12 SC

ER

5 WFA

- 1 DE

A.G03

1A BED

54 m<sup>2</sup>

1A BED

BAL A

 $_{\rm m}$  15  ${\rm m}^{\rm 2}$ 

BAL A

+ RL 178900

+ RL 178900

A.G05

A.G06

2A BED

74 m<sup>2</sup>

16.5m2 BM

32.8m2

Native fern

21 m<sup>2</sup>

RL 178900

7 54 m<sup>2</sup>

4m2 CRM

+ RL 178596

BOOM GATE

RGROUND

+ RL 178510

3m2 LM

-1 LC

—13m<sup>2</sup>CRM

5 WFA —

AS

1 AS

ASM ASM ASM SC

15m2 CRM

+ RL 17787

+ RL 17779

+ RL 17778

+ RL 17769

WEAWER WEAL WEAL LGS

6 LGS

– 22m2 LM

JULY 2025

CHECKED:

R.F

14 WFA

SERVICES

= Tree

1 WF

13 ASM

\_\_\_ *5 RE* 

7R10178900

COMMS

AZ AZ AZ

- 9m2 DT

19 Px

3 Cya

1 DE -

2 PTP

LANDSCAPE PLAN-DEVELOPMENT APPLICATION BLOCK A & B 1:100@ A1 **10m** LPDA 24 - 182 K.Z/E.W

\_\_\_1 CA

5. ALL PLANTING AROUND EXISTING TREES SHALL BE ADJUSTED TO AVOID DAMAGE AND CLASHING WITH SURFACE 6. THE NATURE STRIP (STREET FRONTAGE) FOR THE SITE IS PUBLIC LAND, AND ONLY AUTHORIZED WORKS MAY OCCUR HERE. EXISTING CONDITIONS SUCH AS STREET TREES, COUNCIL PLANTING ETC SHALL BE RETAINED AND PROTECTED DURING CONSTRUCTION, UNLESS SPECIFIC APPROVAL HAS BEEN GRANTED FOR NEW WORK IN THIS AREA. 7. ALL TREES TO BE SOURCED IN ACCORDANCE WITH TESTS AND MEASUREMENTS CONTAINED WITHIN AS 2303-2015 - TREE STOCK FOR LANDSCAPE USE DRAINAGE PITS AND DRAINAGE LINES SHOULD BE LOCATED WITHIN GARDEN AREAS TO ALLOW FOR SITE **PLANTING SCHEME** WHERE POSSIBLE, PITS AND LINEWORK SHOULD BE WHERE PITS AND LINEWORK OCCUR WITHIN GARDEN BEDS, THE LANDSCAPE CONTRACTOR SHALL TAKE ALL PRECAUTIONS TO AVOID DAMAGING STORM WATER WHEN PLANTING SHRUBS AND TREES. LANDSCAPE DESIGNED TO DIRECT OVERLAND FLOW.

LEGEND & SCHEDULE

1. ALL FINAL PLANT QUANTITIES INDICATED ON PLANS SHALL

BE CHECKED AND VERIFIED BY SUCCESSFUL LANDSCAPE

LANDSCAPE CONTRACTOR TO BEST MATCH SUBSTITUTED

3. WORKS CERTIFIED FOR FINAL OCCUPANCY CERTIFICATE

STORM WATER & DRAINAGE SERVICES. LOCATE TREES A

4. LANDSCAPE CONTRACTOR SHALL LOCATE AND AVOID SITE

PLANTS AND APPROVED PRIOR TO PURCHASING BY THE

2. ANY PLANT SUBSTITUTES REQUIRED DUE TO

ARE TO MATCH APPROVED LANDSCAPE PLANS.

UNAVAILABILITY SHALL BE RECOMMENDED BY THE

CONTRACTOR.

LANDSCAPE ARCHITECT.

MINIMUM 1.25M FROM PITS

TO ALL GARDEN AREAS, INCLUDING RAISED PLANTERS, UPPER FLOOR PLANTERS AND GARDENS IN NATURAL GROUND. THE SYSTEM BY A LICENCED CONTRACTOR OR LANDSCAPER. 'AS BUILT' PLAN OF THE SYSTEM TO THE SUPERINTENDENT FOR STRATA RECORDS, FOR FUTURE MAINTENANCE.

Retaining wall details to engineers design. garden bed areas (using non-floatable mulch) without

The Design & location of new letter boxes shall be in Mail to Residential Premises" published Feb '97. All noxious continually removed & suppressed. Reinstate all boundary rear of building line, rake to 1m forward of BL. Pollution, sediment & erosion control devices as specified shall be in

**DA** approved landscape plan's are required to be constructed as approved to obtain occupancy certificate. Permeable areas may be indicated to achieve site coverage restrictions &

DRAINAGE WHILE MINIMISING IMPACT ON THE PROPOSED LOCATED AT THE EDGE OF LANDSCAPE STRIPS TO AVOID PRECLUDING PLANTING CENTRALLY IN GARDEN AREAS. CONTRACTORS SHALL NOT ALTER THE FORM OF SWALES

SYSTEM SHALL BE PROFESSIONALLY INSTALLED THE IRRIGATION PERFORMANCE SPECIFICATION,

and hydraulics plans. Work specific to these plans should be prepared in accordance to these plans, including specification and details prior to the installation of landscaping, and should not be altered or compromised during landscape construction. Elements such as drainage swales may be incorporated in

This plan has been prepared for Development Application approval only, not for construction.

This plan has been prepared with reference to *Hornsby Shire* Council Landscaping Guidelines & requirements. Planting proposed using commercially available plant species selected from local planting lists and the BASIX local plant list (acceptable for BASIX planting).

accordance with Australia Post's "Requirements for Delivery of 30m² Native Fern weeds listed in Councils weed lists & located on the site shall be fencing in poor condition with Council approved 1.8m fencing to place, and maintained for the duration of the construction period. Proposed excavation near existing established trees to be supervised by arborist.

should be constructed as drawn on this plan.

Planting to AG01: - 1 CSB - 2 SC - 1 ASM - 13m2 MPY LP-09 Planting to AG08:

Proposed street

tree to include:

Proposed planting

fence to include:

Screen planting

- 1 ASM

Feature

Groundcover

- 14.1m2 MPY

Planting to AG02:

- 13.3m2 DT

- 11.5m2 LL

- 3 DE

- 1 CSB - 12 MT - 6 CGBF - 8m2 BM

- 17m2 PP

- 1 CSB - 4 CGBF

ш

- 11m2 CAR

Planting to AG07:

Planting to COS:

- 7 ASM

- 15 PX

- 5m<sup>2</sup> LM /

23m² VH

1 CYA

- 1 CG

- 3 SC

- 1 SR - 12m2 PP

SR

+ RL 17

in front of front

- 16 WFA

- 1 TLL

A WEA WEAW

+ RL 178900

A.G02

2A BED

71 m<sup>2</sup>

A.G01

1A BED

54 m<sup>2</sup>

POS A

52 m<sup>2</sup>

+ RL 178900

POS A

53 m<sup>2</sup>

RL 178900

A.G08

1A BED

54 m<sup>2</sup>

A.G07

1A BED

POS A

RL 178900

AC

MTAMTAMTAMT


CG


## AN AUTOMATED COMMERCIAL GRADE IRRIGATION SHALL BE DESIGNED AND INSTALLED IN LINE WITH THE LICENCED CONTRACTOR SHALL PREPARE AN

## LANDSCAPE PLAN NOTES

# This plan should be read in conjunction with the architectural

## compromising the capacity or form.

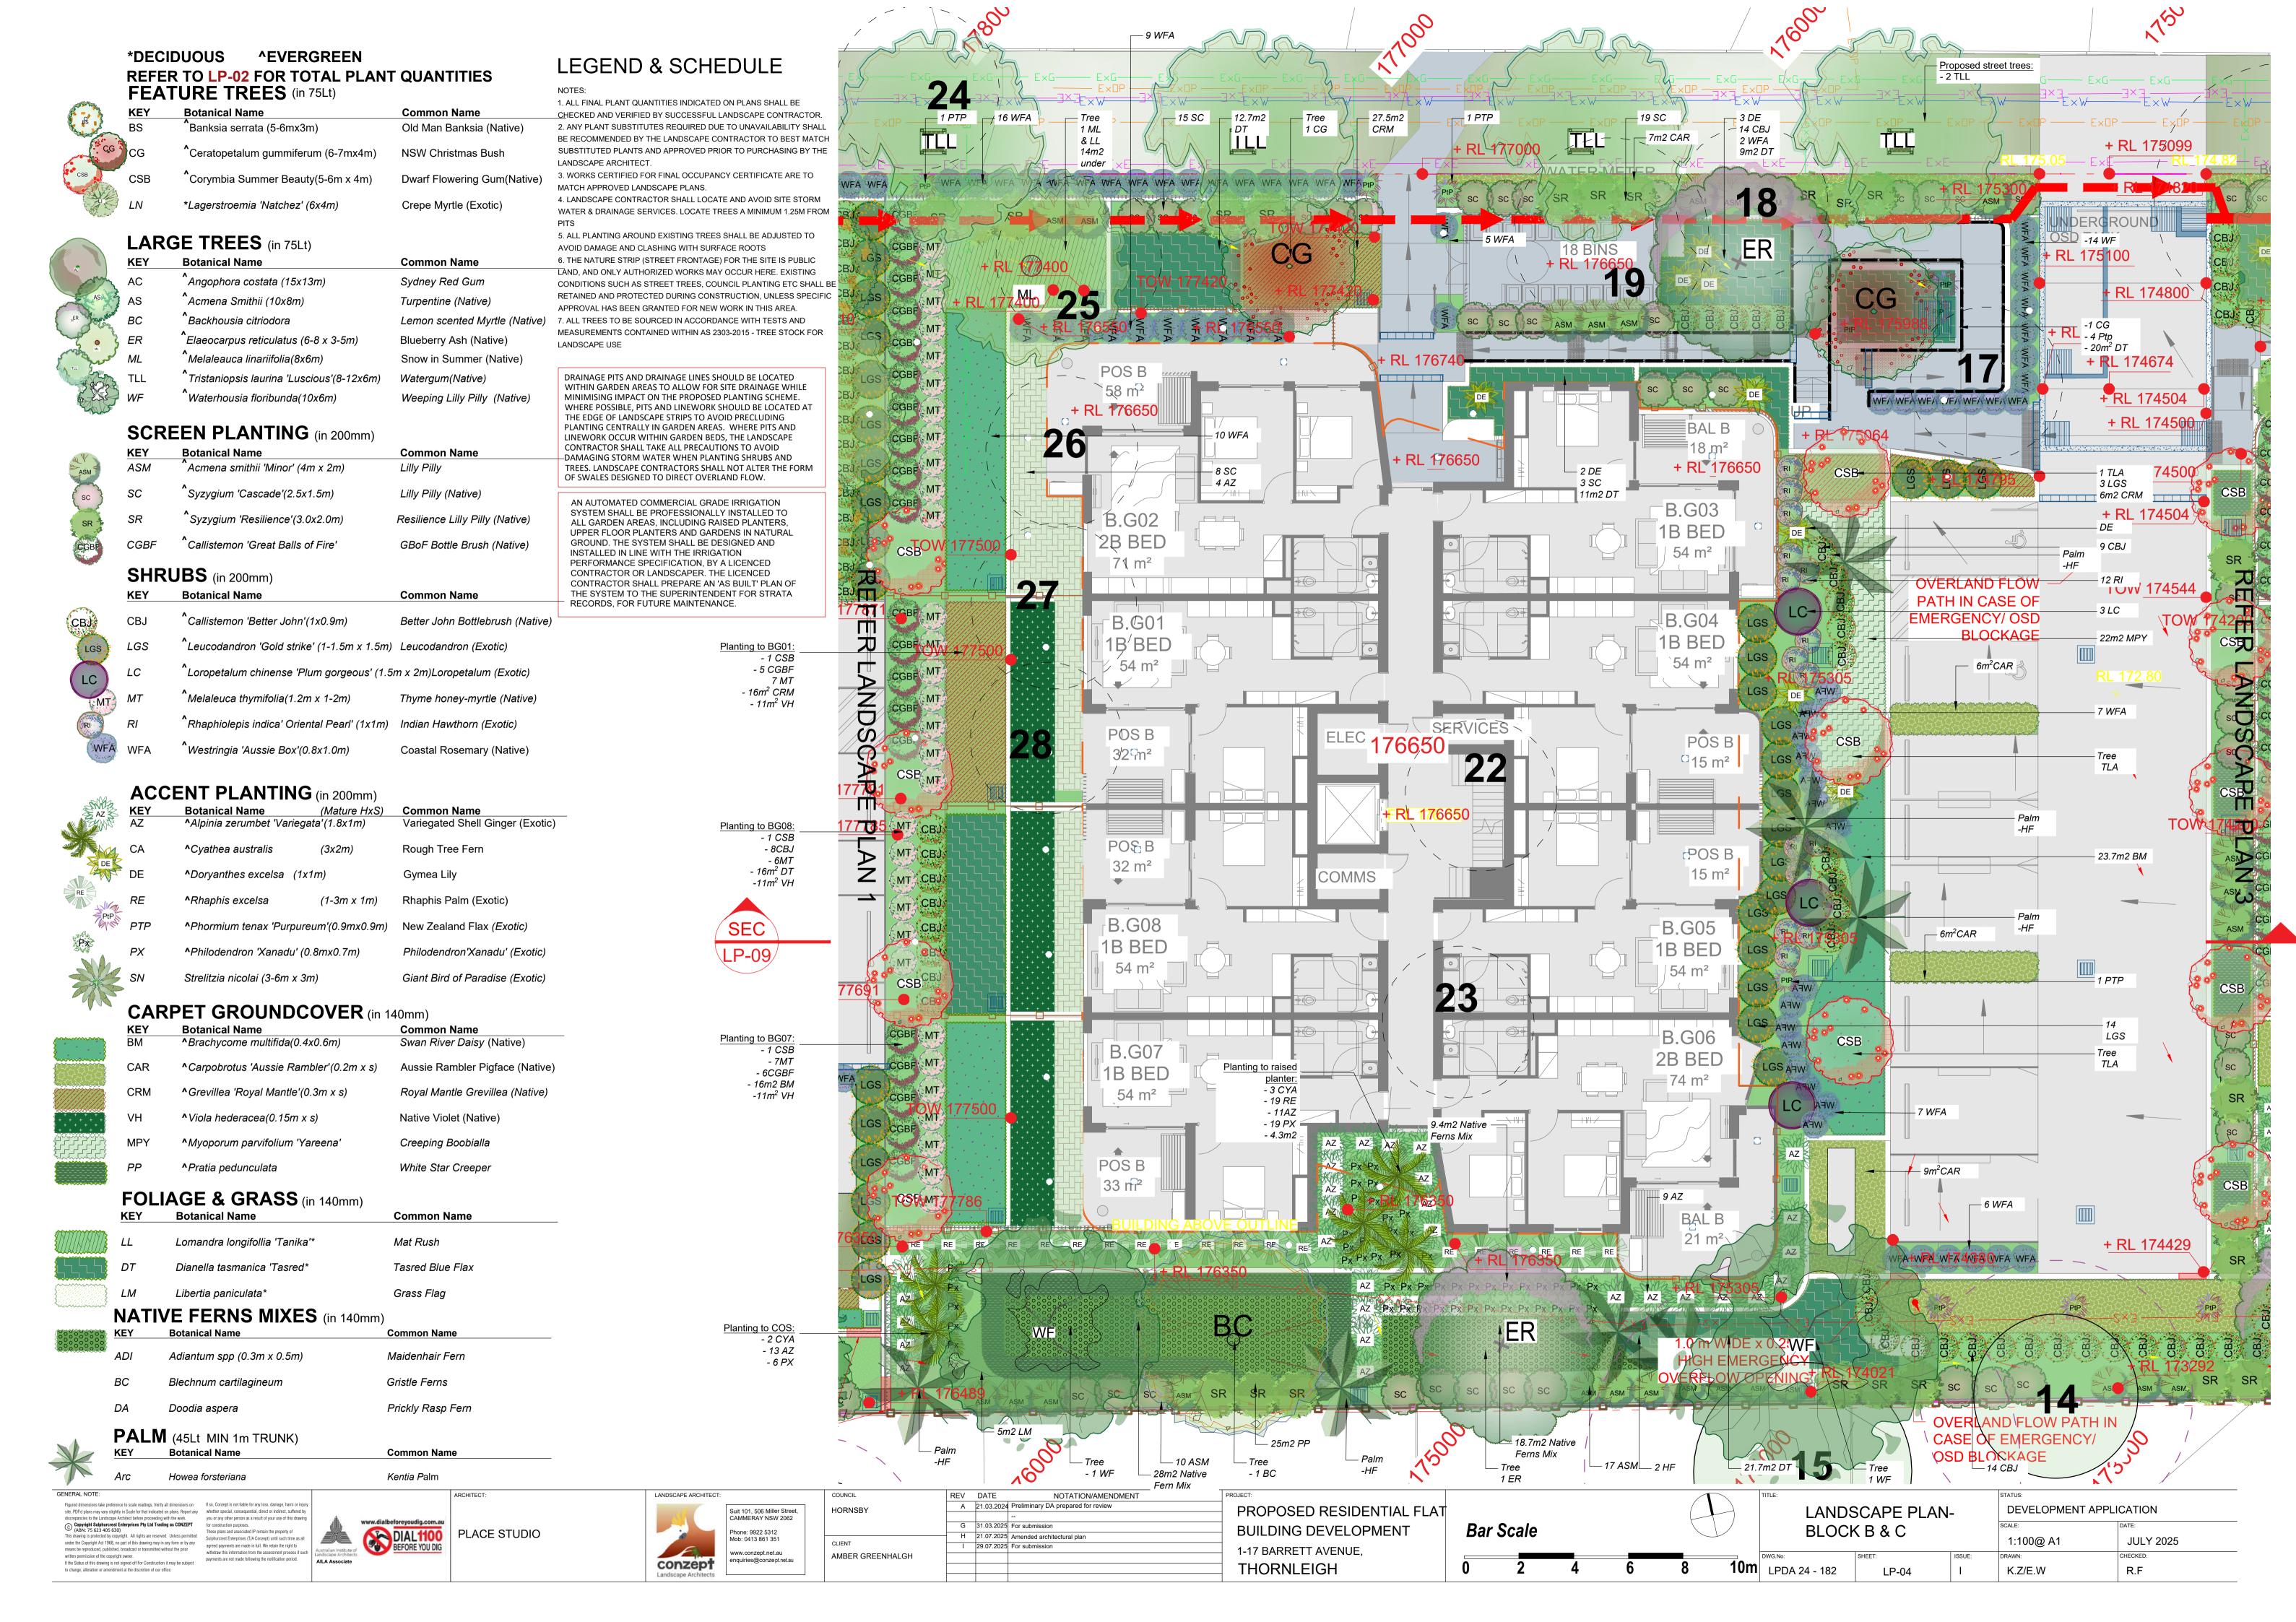

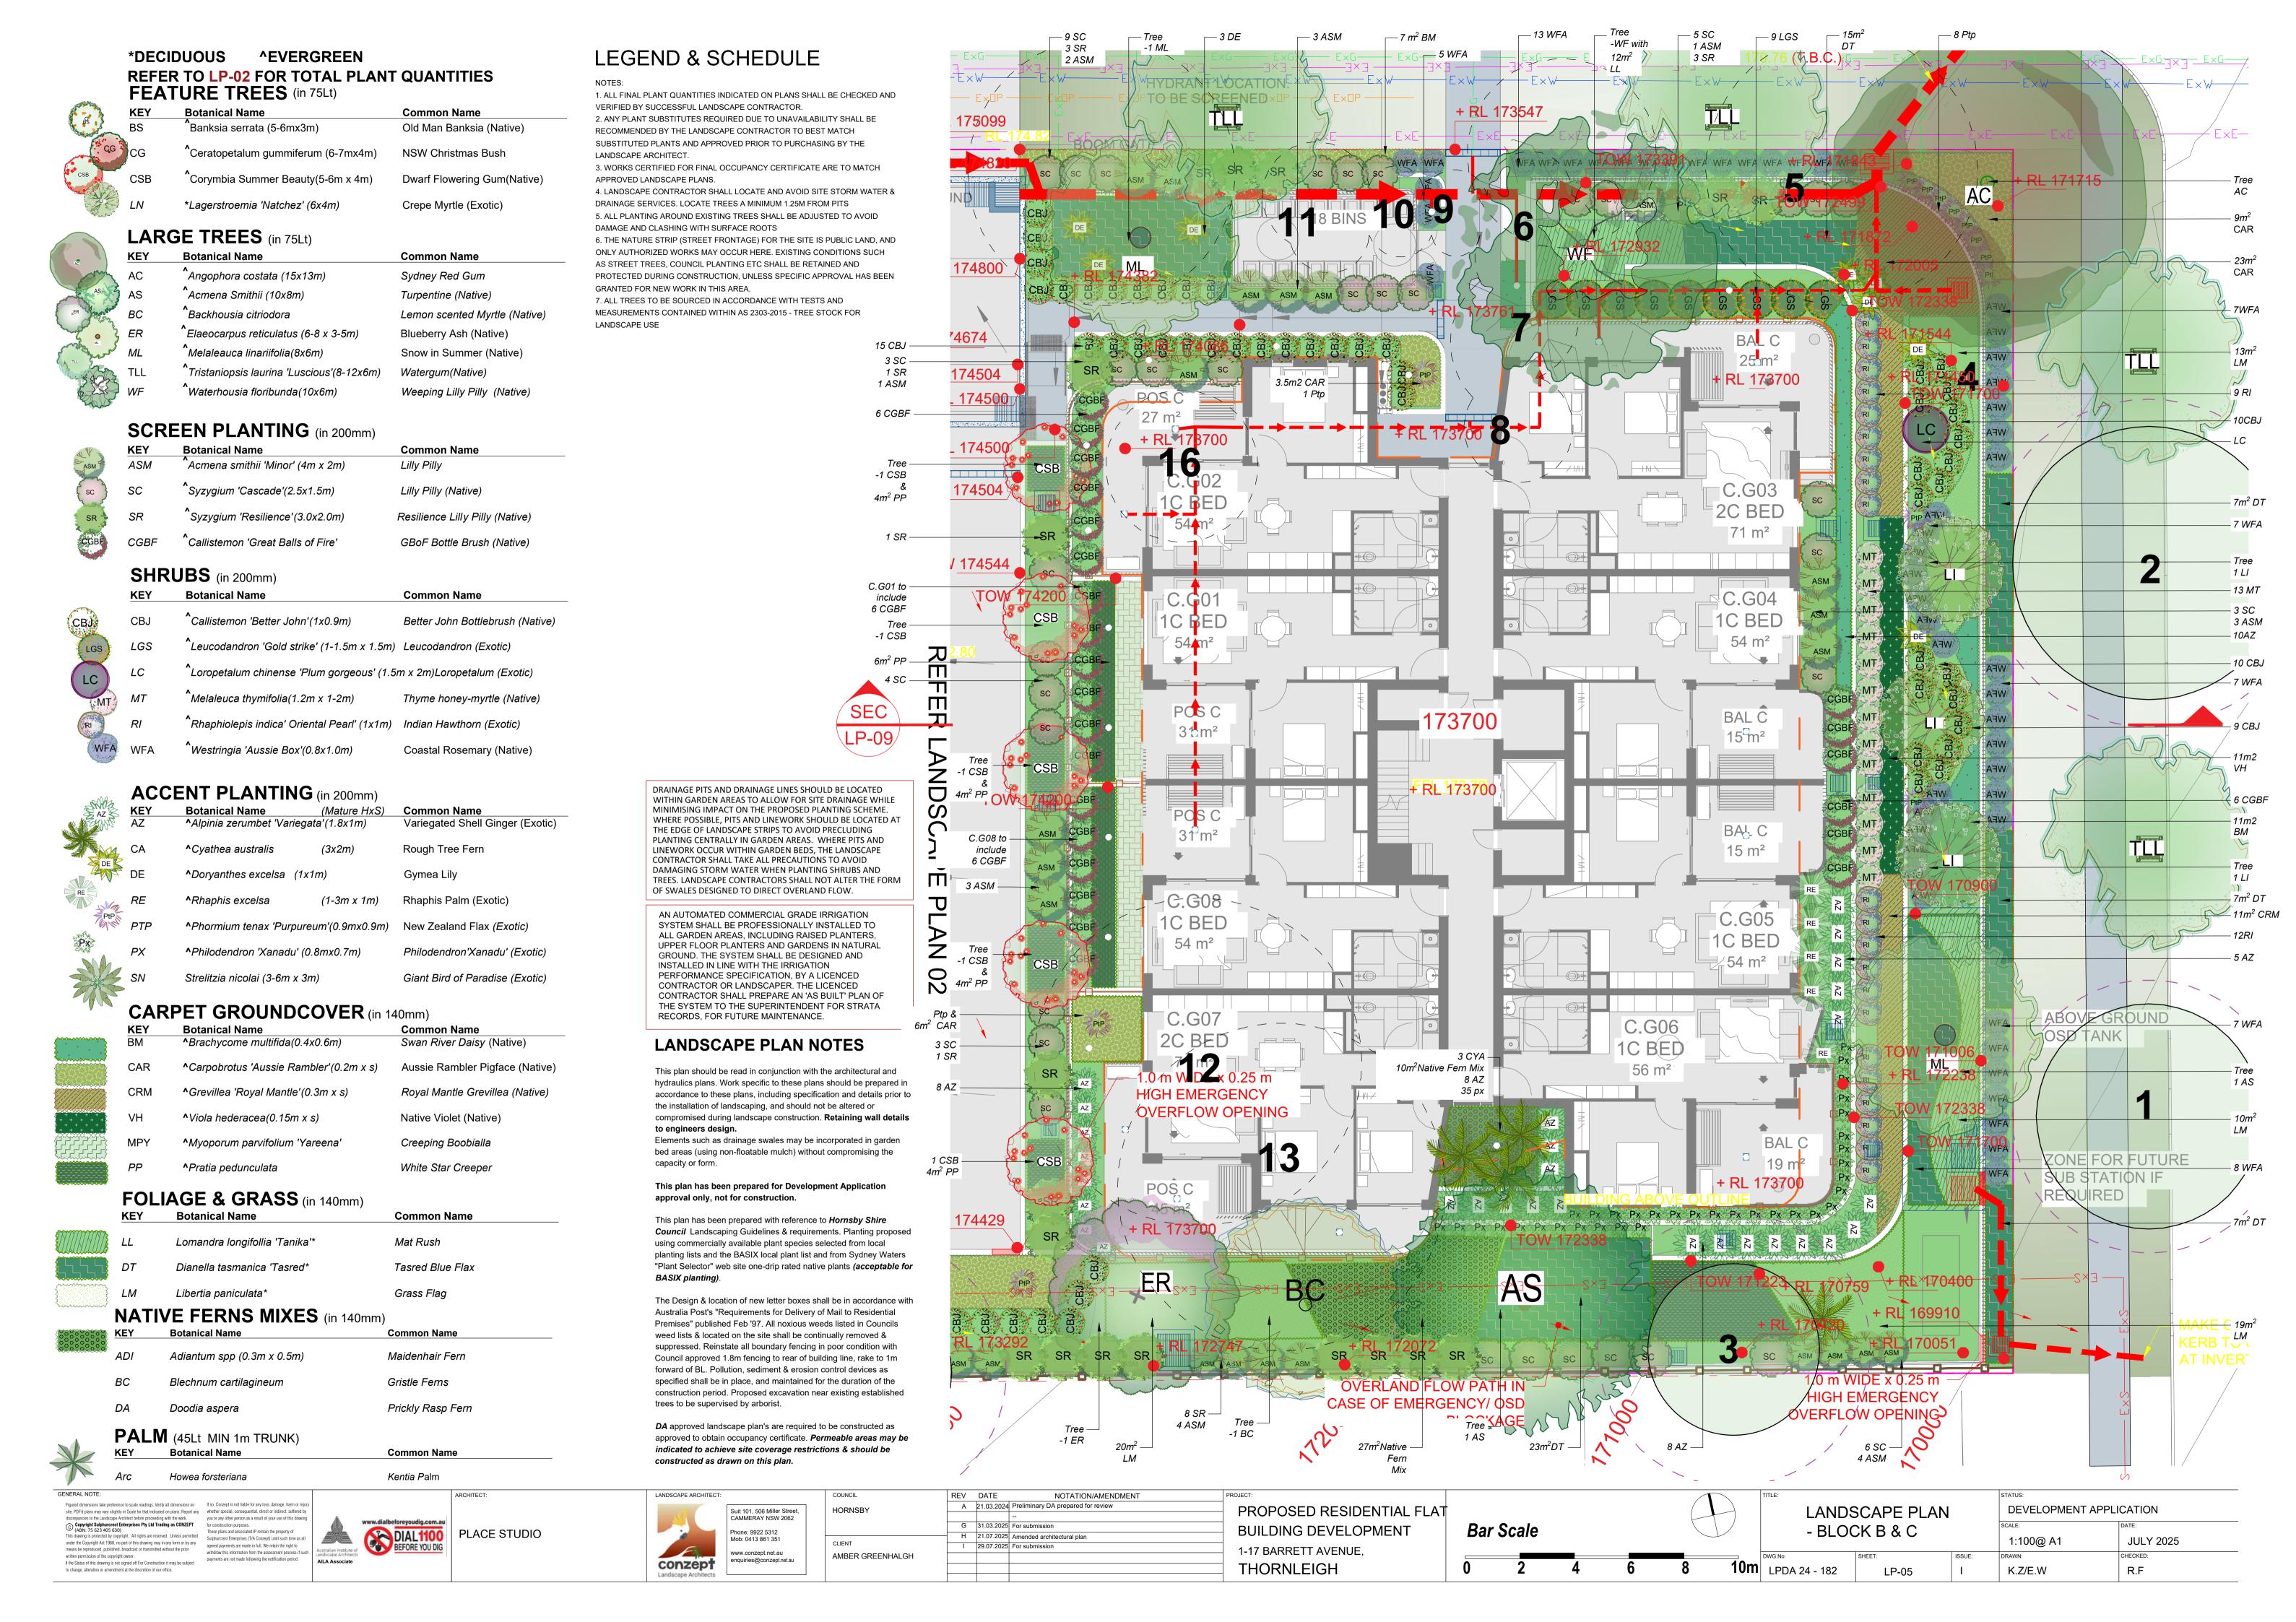













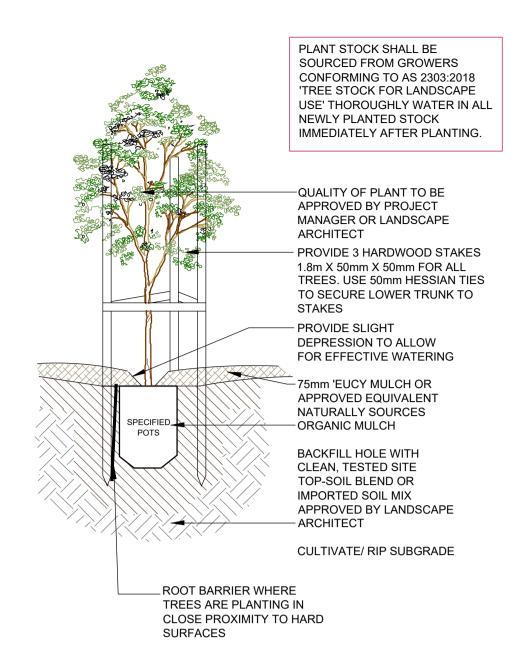

#### TREE PLANTING DETAIL

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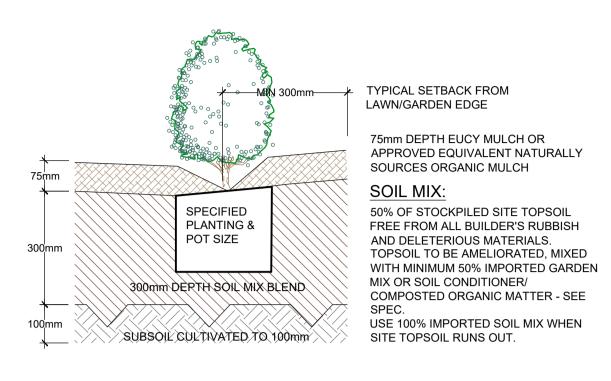
(ONLY APPLICABLE FOR PLANTING AREA OUTSIDE TREE PROTECTION ZONE OF TREES TO BE RETAINED. NO CHANGES ARE TO OCCUR TO EXISTING LEVELS, INCLUDING RIPPING/CULTIVATING OF THE SOIL WITHIN THE TPZ OF TREES TO BE RETAINED ON SITE)

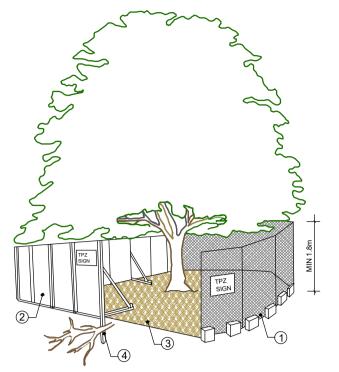

- 1. CHAIN WIRE MESH PANELS WITH SHADE CLOTH (IF REQUIRED) ATTACHED, HELD IN PLACE WITH CONCRETE FEET
- 2. ALTERNATIVE PLYWOOD OR WOODEN PALING FENCE PANELS. THE FENCING MATERIAL ALSO PREVENTS BUILDING MATERIALS OR SOIL ENTERING THE TPZ
- 3. MULCH INSTALLATION ACROSS SURFACE OF TPZ (AT THE DISCRETION OF THE PROJECT ARBORIST). NO EXCAVATION, CONSTRUCTION ACTIVITY, GRADE CHANGES, SURFACE TREATMENT OR STORAGE OF MATERIALS OF ANY KIND IS PERMITTED WITHIN THE TPZ
- 4. BRACING IS PERMISSIBLE WITHIN THE TPZ. INSTALLATION OF SUPPORTS TO AVOID DAMAGING ROOTS
- 5. PRUNING & MAINTENANCE TO TREE REFER TO AS 4373-2007 PRUNING OF AMENITY TREES


PROVIDE FENCING AS DETAILED TO ALL TREES PROPOSED TO BE RETAINED ON THE SUBJECT SITE. FENCING TO BE LOCATED TO THE DRIP LINE OF TREES OR AS INDICATED ON PLANS OR DIRECTED ON-SITE BY ARBORIST. NO STOCKPILING WITHIN FENCE PERIMETERS.


## TREE PROTECTION ZONE




### TYPICAL GARDEN PREPARATION DETAIL

(ONLY APPLICABLE FOR PLANTING AREA OUTSIDE TREE PROTECTION ZONE OF TREES TO BE RETAINED. NO CHANGES ARE TO OCCUR TO EXISTING LEVELS, INCLUDING RIPPING/CULTIVATING OF THE SOIL WITHIN THE TPZ OF TREES TO BE RETAINED ON SITE)

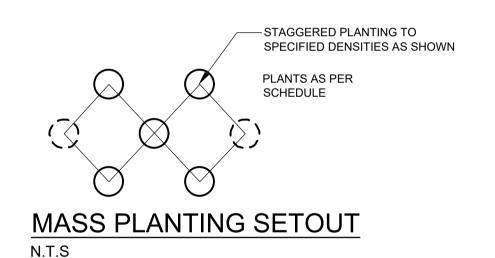


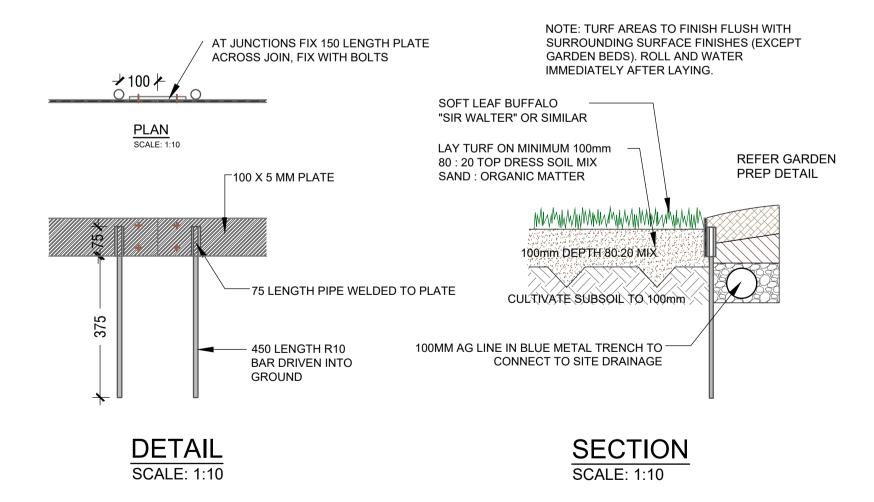

STEEL EDGE DETAIL SCALE: 1:10

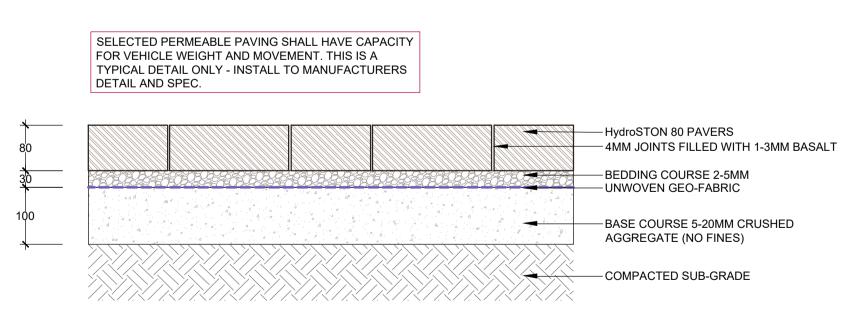


#### PERMEABLE PAVING DETAIL SCALE 1:15

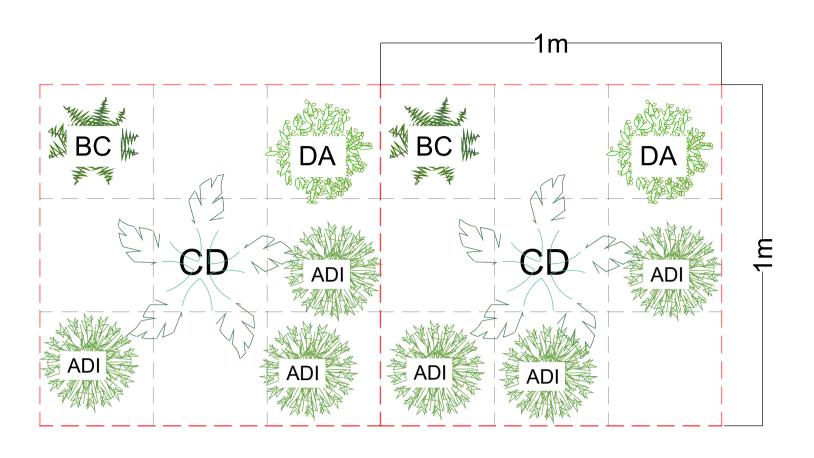

#### NATIVE FERNS MIXES DETAILS (in 140mm)

KEY	Botanical Name	Common Name	Ratio (/m2)
ADI	Adiantum spp (0.3m x 0.5m)	Maidenhair Fern	<b>3</b> /m2
ВС	Blechnum cartilagineum	Gristle Ferns	1/m2
DA	Doodia aspera	Prickly Rasp Fern	1/m2
CD	Christella dentata	Binung	1/m2

NOTE: TYPICAL DETAIL ONLY. ALL WALLS WHICH FORM PART OF DRAINAGE WORKS MUST BE BUILT AS DETAILED BY THE HYDRAULIC ENGINEER. ALL WALLS REFERS TO DETAILS BY PROJECT CIVIL ENGINEER . INSTALL WALL TO SUIT SITE LEVELS AND TO MANUFACTURE'S SPECIFICATION.

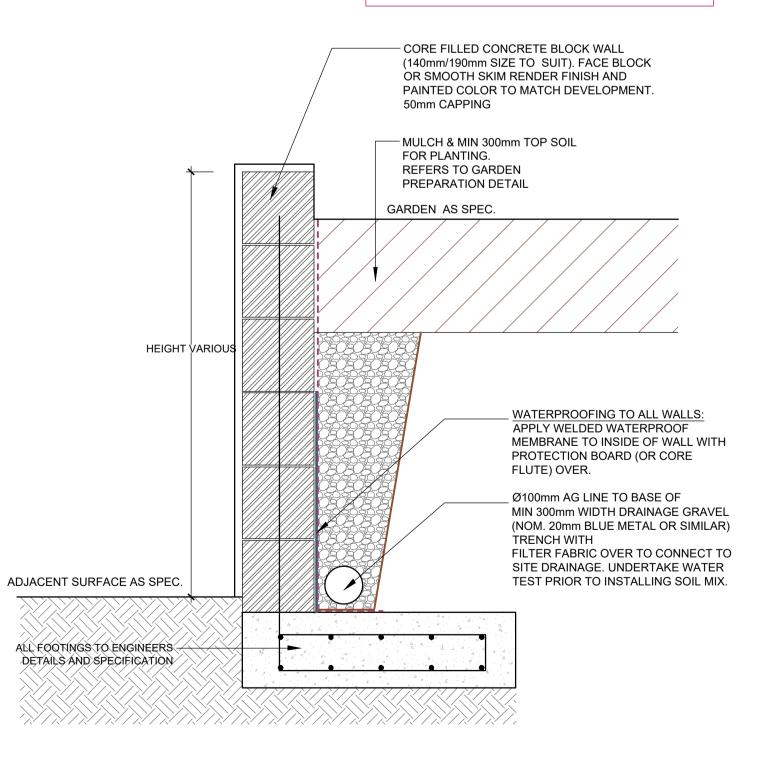

#### TYPICAL MASONRY BLOCK RETAINING WALL APPROX 1:10

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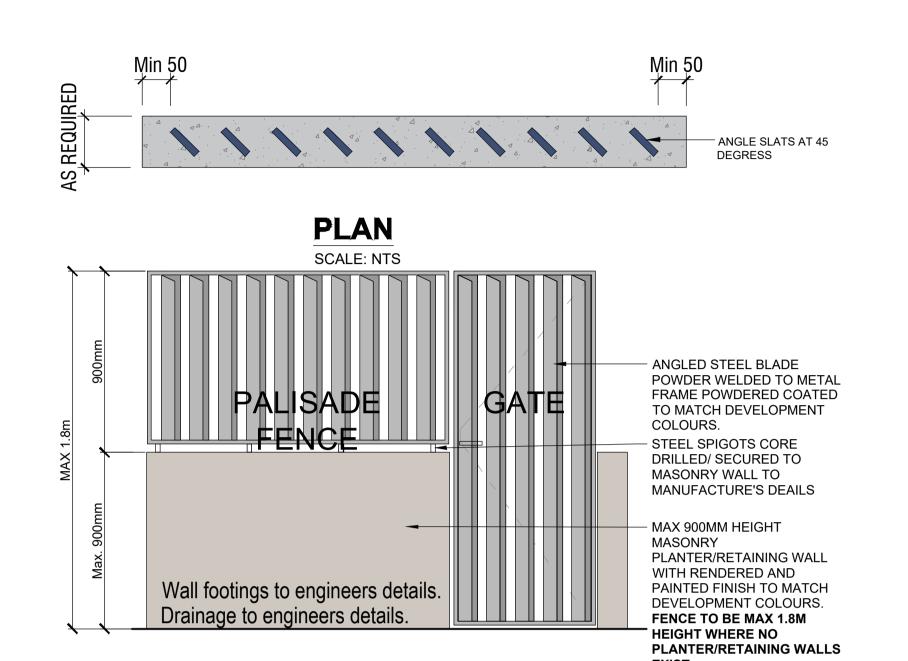
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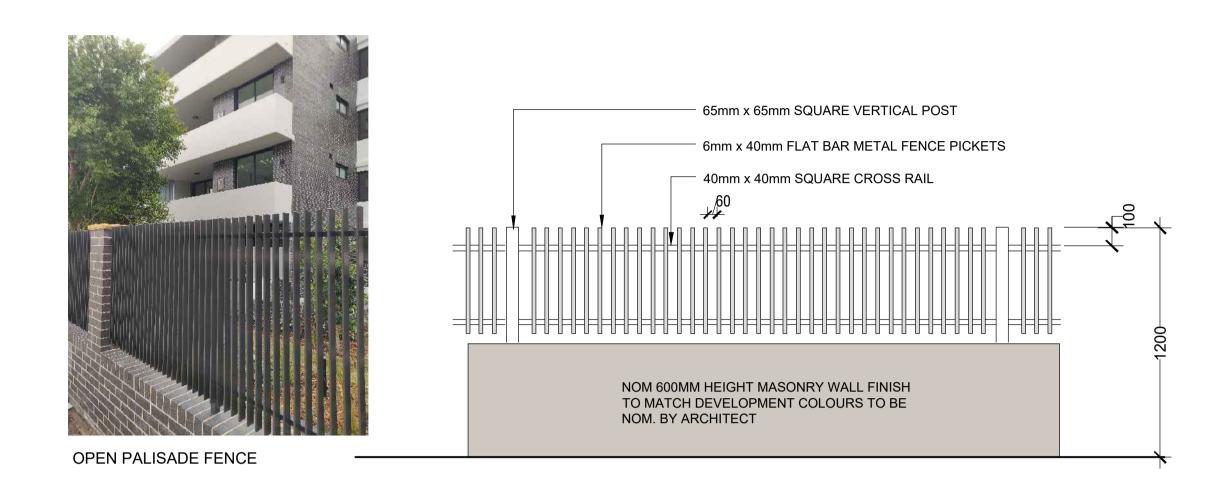
NOTATION/AMENDMENT COUNCIL A 21.03.2024 Preliminary DA prepared for review G 31.03.2025 For submission H 21.07.2025 Amended architectural plan I 29.07.2025 For submission AMBER GREENHALGH

PROPOSED RESIDENTIAL FLAT **BUILDING DEVELOPMENT** 1-17 BARRETT AVENUE. **THORNLEIGH** 

LANDSCAPE DETAILS DEVELOPMENT APPLICATION AS SHOWN @ A1 **JULY 2025** LPDA 24 - 182 R.F LP-07 K.Z/E.W



TYPICAL COURTYARD FENCE DETAIL SCALE 1:20



TYPICAL METAL PALISADE FRONT FENCE DETAIL SCALE 1:20



GENERAL NOTE: Figured dimensions take preference to scale readings. Verify all dimensions on site. PDFd plans may vary slightly in Scale for that indicated on plans. Report any discrepancies to the Landscape Architect before proceeding with the work.

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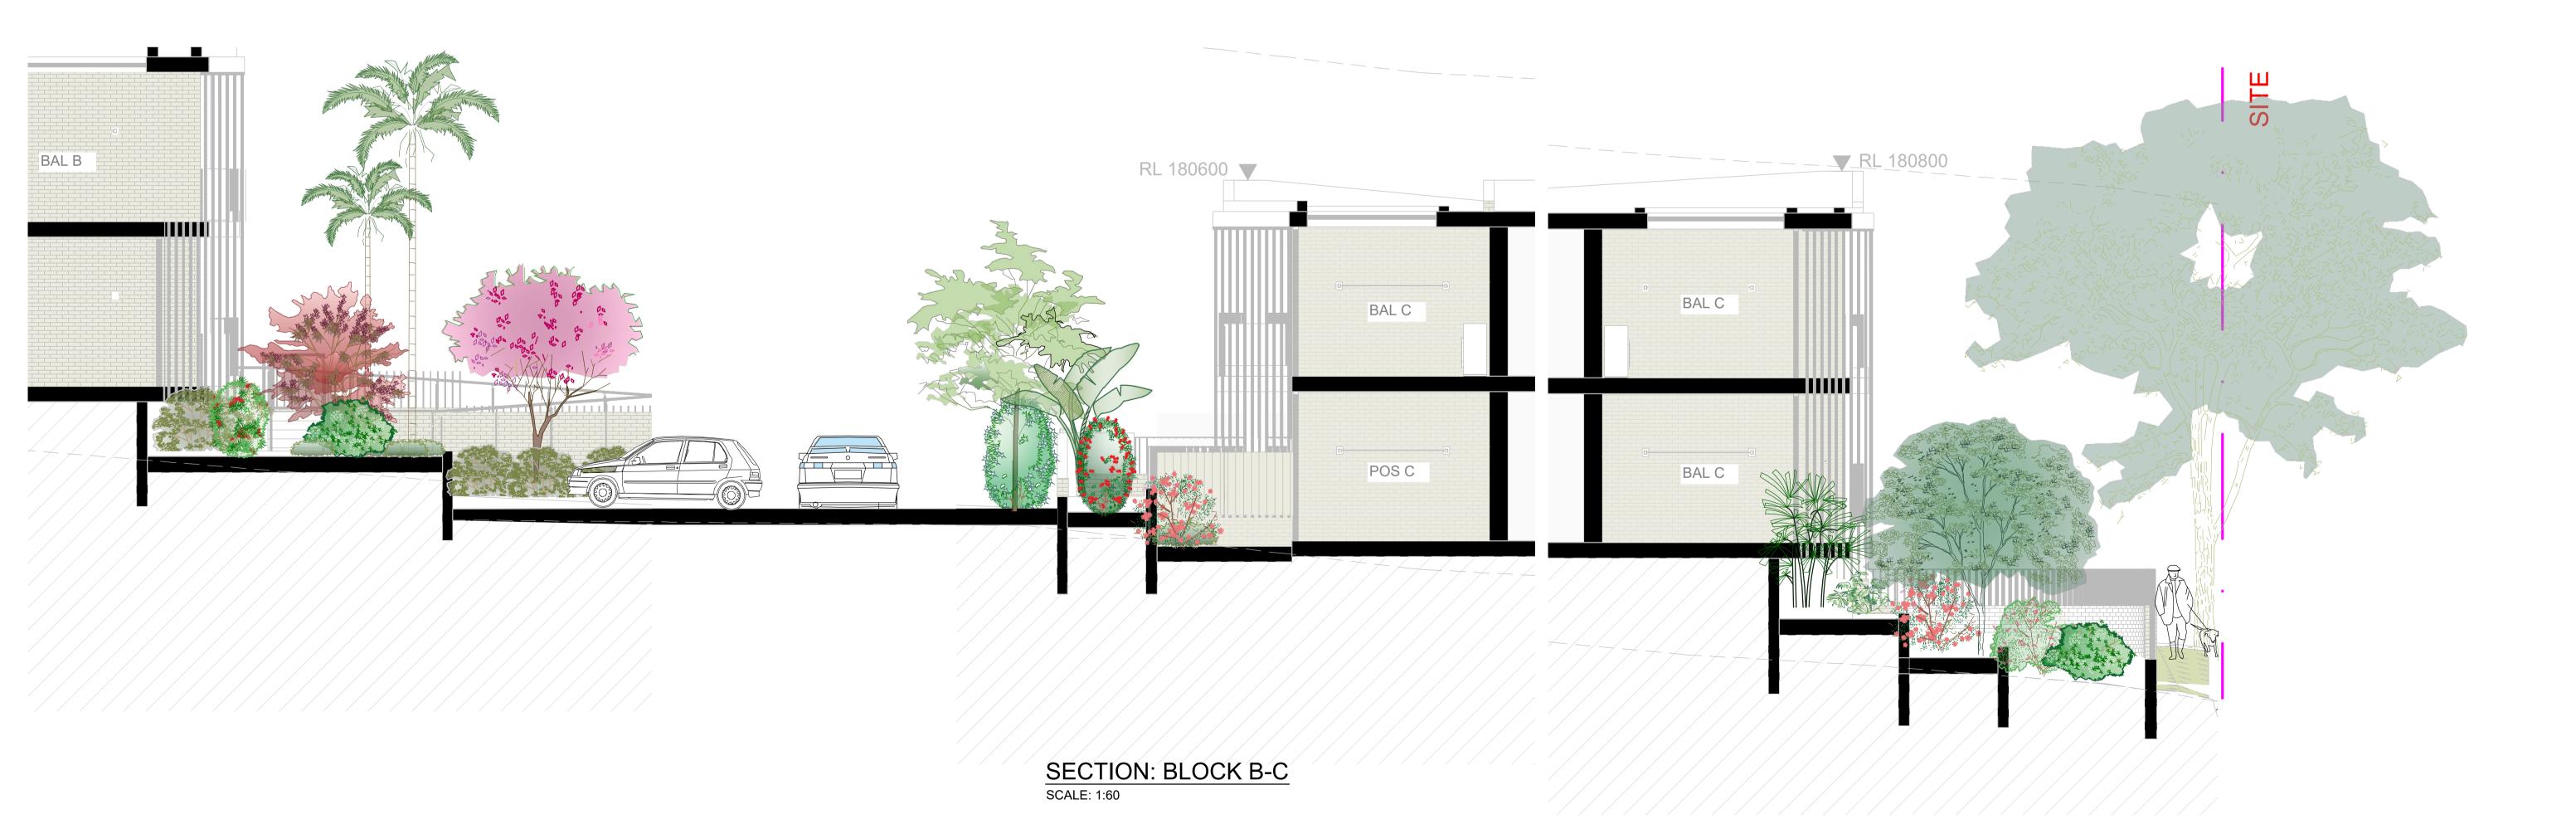
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PROPOSED RESIDENTIAL FLAT **BUILDING DEVELOPMENT** 1-17 BARRETT AVENUE, THORNLEIGH

FENCE DETAILS DEVELOPMENT APPLICATION AS SHOWN JULY 2025 CHECKED: K.Z/E.W LPDA 24 - 182 R.F LP-08



SECTION: BLOCK A-B
SCALE: 1:60



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PROPOSED RESIDENTIAL FLAT BUILDING DEVELOPMENT 1-17 BARRETT AVENUE, THORNLEIGH

DEVELOPMENT APPLICATION SECTIONS AS SHOWN @ A1 JULY 2025 LPDA 24 - 182 K.Z/E.W R.F LP-09